DISTRICT OFFICE RENOVATION/REMODELING: OPERATIONS BUILDING 1 WEST END

925 W. CENTER ST, GREEN COVE SPRINGS, FL 32043

SCHOOL DISTRICT OF CLAY COUNTY

SDCC PROJECT No. C-30-19/20



DAVID BROSKIE * SUPERINTENDENT OF SCHOOLS

JANICE KEREKES

CAROL STUDDARD

DISTRICT 1 BOARD MEMBER

DISTRICT 2 BOARD MEMBER

DISTRICT 3 BOARD MEMBER

MARY BOLLA

DISTRICT 4 BOARD MEMBER

ASHLEY GILHOUSEN DISTRICT 5 BOARD MEMBER

BID ISSUE

BRIAN BOATRIGHT

ARCHITECT

914 PLAINFIED AVENUE


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FI: AA26003151,AR12659,D5414



RATIONS BUILDING 1 WEST END

REVISIONS
NO DATE COMMENT

JOB NO. 191003
DATE 5-9-202
DRAWN BY BOB
CHECKED BY BOB

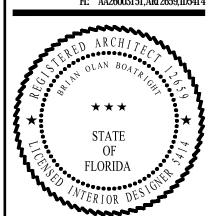
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GENERAL NOTES AND INSTRUCTIONS

- 1. THESE DRAWINGS ARE THE PROPERTY OF THE ARCHITECT AND MAY BE REPRODUCED ONLY WITH THE WRITTEN PERMISSION OF THE ARCHITECT. AUTHORIZED REPRODUCTIONS MUST BEAR THE NAME OF THE ARCHITECT. THESE DRAWINGS ARE FULLY PROTECTED BY FEDERAL AND STATE COPYRIGHT LAWS. ANY INFRINGEMENT WILL BE VIGOROUSLY PROSECUTED.
- 2. DRAWINGS AND NOTES ARE NOT EXHAUSTIVE AND ALL WORK SHALL ADHERE TO THE APPLICABLE CODES AND STANDARDS WHETHER OR NOT IT IS SHOWN ON THE DRAWINGS. THE CONTRACT DOCUMENTS HAVE BEEN PREPARED WITH DUE CARE AND DILIGENCE, HOWEVER THE ARCHITECT CANNOT GUARANTEE PERFECTION. FAILURE TO NOTIFY THE ARCHITECT OF DISCREPANCIES AND CHANGES WITHOUT THE WRITTEN CONSENT OF THE DESIGN TEAM RELIEVES THE ARCHITECT OF THE RESPONSIBILITY FOR ALL CONSEQUENCES ARRIVING FROM SUCH CHANGES OR DISCREPANCIES. MINOR DETAILS OR MEANS AND METHODS NOT USUALLY SHOWN OR SPECIFIED BUT REQUIRED FOR PROPER COMPLETION OF THE WORK ARE INCORPORATED INTO THE CONTRACT DOCUMENTS AS IF THEY WERE SHOWN.
- 3. THE ARCHITECT SHALL NOT BE RESPONSIBLE WHERE CONSTRUCTION DEVIATES FROM THESE DRAWINGS OR FROM WRITTEN RECOMMENDATIONS. CHANGES TO THE PLANS BY THE OWNER AND/OR CONTRACTOR SHALL BE THE RESPONSIBILITY OF THE PERSONS MAKING SUCH CHANGES. THE OWNER AND/OR CONTRACTOR SHALL HOLD THE ARCHITECT HARMLESS FROM AND AGAINST ALL CLAIMS, DAMAGES, LOSSES AND EXPENSES INCLUDING, BUT NOT LIMITED TO, ATTORNEY'S FEES ARISING OUT OF OR RESULTING FROM THE PERFORMANCE OF THE WORK BY THE CONTRACTOR. THE ARCHITECT SHALL NOT HAVE CONTROL OR CHARGE OF AND SHALL NOT BE RESPONSIBLE FOR CONSTRUCTION MEANS, METHODS, TECHNIQUES, SEQUENCES OR PROCEDURES, FOR SAFETY PRECAUTIONS AND PROGRAMS IN CONNECTION WITH THE WORK, FOR THE ACTS OR OMISSIONS OF THE CONTRACTOR, SUBCONTRACTORS, FOR ANY OTHER PERSONS PERFORMING ANY OF THE WORK, OR FOR THE FAILURE OF ANY OF THEM TO CARRY OUT THE WORK IN ACCORDANCE WITH THE CONTRACT DOCUMENTS.
- 4. THE ARCHITECT SHALL HAVE NO RESPONSIBILITY FOR THE DISCOVERY, PRESENCE, HANDLING, REMOVAL, DISPOSAL OR EXPOSE OF PEOPLE TO HAZARDOUS MATERIALS IN ANY FORM INCLUDING, BUT NOT LIMITED TO, ASBESTOS PRODUCTS POLYCHLORINATED BIPHENYL (PCB) OR OTHER TOXIC SUBSTANCES. NO ASBESTOS CONTAINING PRODUCTS ARE TO BE INSTALLED IN THE PROJECT.
- 5. THE CONTRACTOR SHALL SECURE AND PAY FOR ALL GOVERNMENTAL PERMITS, FEES, LICENSES, AND INSPECTIONS NECESSARY FOR PROPER EXECUTION AND COMPLETION OF THE WORK, CONTRACTOR IS ALSO RESPONSIBLE FOR ARRANGING ALL OTHER WORK REQUIRED TO MAKE THE BUILDING OCCUPIABLE, OPERATIVE, AND IN AGREEMENT WITH THE DESIGN INTENT DOCUMENTED IN THE DRAWINGS AND SPECIFICATIONS. CONTRACTOR IS RESPONSIBLE FOR THE COORDINATION OF SUBCONTRACTORS, INSPECTIONS, TRADES AND THE MAINTENANCE OF THE PROJECT
- 6. NOTIFY THE ARCHITECT IF THE PROPOSED USE IS NOT IN ACCORDANCE WITH LOCAL AND STATE REQUIREMENTS AND PROVIDE THE ARCHITECT WITH ANY NECESSARY DOCUMENTATION INCLUDING ZONING, SETBACKS, ENVIRONMENTAL REGULATIONS, OR ANY SIMILAR CONSTRAINTS WHICH MAY AFFECT THE PROJECT. HOWEVER, IN NO CASE SHALL ANY PART OF THE DWELLING OR ANY OTHER STRUCTURE BE LOCATION WITHIN 3'-0" OF A PROPERTY LINE WITHOUT APPROVAL OF THE ARCHITECT.
- 7. INCLUDED ENGINEERS' DRAWINGS TAKE PRECEDENCE OVER ARCHITECTURAL IN REGARD TO CIVIL, STRUCTURAL, MECHANICAL, AND ELECTRICAL ENGINEERING CONTENT. HOWEVER CONFLICTS ARE TO BE RESOLVED BY THE ARCHITECT AFTER WRITTEN NOTIFICATION BY THE CONTRACTOR AND IN CONSIDERATION OF THE RELEVANT ARCHITECTURAL DETAILS.
- 8. WHEN NOT PROVIDED IN THE CONTRACT DOCUMENTS, THE DESIGN OF HEATING, VENTILATION AND AIR CONDITIONING, PLUMBING, GAS AND ELECTRICAL SYSTEMS ARE TO BE PROVIDED BY THE CONTRACTOR, INCLUDING THE PREPARATION OF REQUIRED DRAWINGS AND COORDINATION WITH THE ARCHITECTURAL DRAWINGS. THE ARCHITECTURAL DRAWINGS SHOW THE GENERAL ARRANGEMENT, EXTENT AND INTENT OF THE WORK.
- 9. INSTALL ALL WORK PLUMB, TRUE, LEVEL AND WITH GOOD WORKMANSHIP. THE ARCHITECT RESERVES THE RIGHT TO REJECT INFERIOR WORK. INFERIOR WORK SHALL BE REPLACED AS DIRECTED WITHOUT ADDITIONAL COST TO THE OWNER.
- 10. INSTALL ALL MATERIALS, PRODUCTS AND EQUIPMENT TO THE MANUFACTURERS' INSTRUCTIONS, RECOMMENDATIONS AND THE STANDARD OF RECOGNIZED AGENCIES AND ASSOCIATIONS. PROVIDE ADEQUATE BLOCKING/SUPPORT FOR ALL EQUIPMENT, CABINETS, ETC. PROVIDE ALL ANCHORS, FASTENERS AND ACCESSORIES REQUIRED FOR A COMPLETE INSTALLATION, ALLOW FOR THERMAL EXPANSION, CONTRACTION AND BUILDING MOVEMENT. SEPARATE INCOMPATIBLE MATERIALS WITH SUITABLE MATERIALS OR SPACING. PREVENT CATHODIC CORROSION. PROTECT BETWEEN MATERIALS/STRUCTURE AS INDICATED AND AS REQUIRED BY THE MANUFACTURER OR RECOGNIZED INDUSTRY STANDARDS. INSTALL PRODUCTS UNDER APPROPRIATE ENVIRONMENTAL CONDITIONS (AIR TEMPERATURE, SURFACE TEMPERATURE, RELATIVE HUMIDITY, ETC.) TO ENSURE QUALITY AND DURABILITY. MAINTAIN PROPER PROTECTION DURING DRYING/CURING.
- 11. WHERE SIZE, CAPACITY, MODEL, STYLE OR OTHER PERTINENT INFORMATION IS NOT SHOWN, FURNISH WORK IN THE FASHION THAT WILL MEET APPLICABLE CODE AND RESULT IN AN OPERABLE BUILDING MEETING THE DESIGN INTENT AND OBTAIN THE ARCHITECT'S WRITTEN APPROVAL PRIOR TO PROCEEDING. WHERE THE COMPLETE SIZES OR DIMENSIONS OF MEMBERS, CONNECTIONS OR FASTENERS OF ANY ITEM ARE NOT INDICATED, DESIGN THE ITEM TO PRODUCE THE STRENGTH APPROPRIATE TO THE USE INTENDED.
- 12. THE CONTRACTOR IS RESPONSIBLE FOR FIELD VERIFICATION OF ALL DIMENSIONS AND CONDITIONS RELIED UPON FOR THE INSTALLATION OF SHOP-FABRICATED OR OTHER FIELD-INSTALLED MATERIALS.
- 13. THE CONTRACTOR IS RESPONSIBLE FOR MAINTAINING A CONSTRUCTION WASTE RECYCLING PROGRAM FOR WOOD, METALS AND CARDBOARD IN ADDITION TO REMOVING ALL RUBBISH AND DEBRIS AND KEEPING A CLEAN SITE. THE CONTRACTOR IS RESPONSIBLE FOR A THOROUGH AND PROFESSIONAL CLEANING PRIOR TO OWNER OCCUPANCY AND COORDINATION OF A FINAL PUNCH LIST PROCESS.
- 14. THE CONTRACTOR SHALL PROVIDE THE OWNER WITH FULL WARRANTY INFORMATION ON ALL PRODUCTS AND EQUIPMENT, AS WELL AS MAINTENANCE AND OPERATION MANUALS INCLUDING MANUFACTURERS' INSTRUCTIONS AND OTHER RELEVANT MATERIAL.
- 15. THE CONTRACTOR SHALL BE RESPONSIBLE FOR THE PROTECTION AND CONTINUOUS MAINTENANCE OF ALL WORK FROM DAMAGE AND SHALL PROTECT THE OWNER'S PROPERTY FROM DAMAGE OR LOSS BY DUST, DIRT, WATER, THEFT, FIRE OR ANY OTHER PHYSICAL DAMAGE IN CONNECTION WITH THE CONSTRUCTION CONTRACT.
- 16. DIMENSIONS SHALL GOVERN. DO NOT SCALE DRAWINGS. ALL DIMENSIONS SHALL BE VERIFIED ON THE SITE BEFORE PROCEEDING WITH THE WORK. THE CONTRACTOR SHALL NOTIFY THE ARCHITECT IN WRITING OF ANY DISCREPANCIES, OMISSIONS AND/OR CONFLICTS BEFORE PROCEEDING WITH THE PORTION OF THE WORK IN QUESTION. CONTRACTOR SHALL HAVE ALL DIMENSIONS FIELD VERIFIED PRIOR TO ORDERING MATERIALS.
- 17. CHECK DETAILS FOR APPROPRIATE LOCATION OF ALL ITEMS NOT DIMENSIONED ON THE DRAWINGS. ALL DOORS ARE LOCATED BY THE FLOOR PLAN DIMENSIONS AND/OR JAMB DETAIL RELATIVE TO THE ADJACENT WALLS AND PARTITIONS. DOORS AND CASED OPENINGS WITHOUT DIMENSIONS ARE TO BE 4" FROM THE FACE OF THE ADJACENT WALL OR CENTERED BETWEEN THE WALLS, UNLESS NOTED OTHERWISE.
- 18. UNLESS NOTED OTHERWISE, ALL WALLS AND PARTITIONS ARE DIMENSIONED TO THE FACE OF THE STUD OR FACE OF THE BLOCK. "ALIGN" MEANS TO ACCURATELY LOCATE FINISHED FACES IN THE SAME PLANE. WHERE SPECIFIC DIMENSIONS, DETAILS AND DESIGN INTENT CANNOT BE DETERMINED, NOTIFY THE ARCHITECT IN WRITING BEFORE PROCEEDING WITH ANY WORK IN QUESTION.

- 19. FOR STRUCTURAL WORK THE CONTRACTOR SHALL REVIEW ALL STRUCTURAL DIMENSIONS AND STRUCTURAL MEMBER SIZES PRIOR TO THE CONSTRUCTION CONTRACTOR SHALL INFORM ARCHITECT OF ANY DISCREPANCIES IN THE DOCUMENTS OR IN CONFLICT WITH THE CODES. CONTRACTOR INITIATED CHANGES SHALL BE SUBMITTED IN WRITING TO THE OWNER, ARCHITECT AND STRUCTURAL ENGINEER FOR APPROVAL PRIOR TO FABRICATION OR CONSTRUCTION. PROVIDE ADEQUATE TIME (10 WORKING DAYS MINIMUM) TO REVIEW PROPOSED CHANGES. CONTRACTOR SHALL BE RESPONSIBLE FOR ALL REQUIRED SAFETY PRECAUTIONS AND: METHODS, TECHNIQUES, SEQUENCES OR PROCEDURES REQUIRED TO PERFORM THE WORK. ALL STRUCTURAL SYSTEMS SUCH AS WOOD PRESSED-PLATE TRUSSES WHICH HAVE COMPONENTS TO BE FIELD-ERECTED SHALL BE SUPERVISED BY THE SUPPLIER DURING MANUFACTURING, DELIVERY, HANDLING, STORAGE AND ERECTION IN ACCORDANCE WITH THE SUPPLIER'S PRINTED INSTRUCTIONS. CONTRACTOR TO COORDINATE STRUCTURAL FRAMING WITH ELECTRICAL, PLUMBING AND MECHANICAL WORK. CONTRACTOR IS RESPONSIBLE FOR THE PROPER OPERATION OF ALL SYSTEMS AND THE COORDINATION OF ALL SYSTEMS AND TRADES. CONTRACTOR TO NOTIFY ARCHITECT AND ENGINEER FOR RESOLUTION OF ALL DISCREPANCIES PRIOR
- 20. ALL WINDOW AND DOOR SIZES AND DIMENSIONS ARE NOMINAL AND THE CONTRACTOR OR SUBCONTRACTOR/INSTALLER IS CHARGED WITH PROVIDING THE CORRECT ROUGH OPENING AS REQUIRED FOR THE CORRECT INSTALLATION OF THE PRODUCT.
- 21. THROUGHOUT THE PLANS ARE ABBREVIATIONS WHICH ARE IN COMMON USE. THE ARCHITECT WILL DEFINE THE INTENT OF ANY IN QUESTION.
- 22. TYPICAL WALL SECTIONS, FINISHES AND DETAILS ARE NOT DUPLICATED EVERYWHERE THEY OCCUR ON PLANS, ELEVATIONS, AND SECTIONS. REFER TO DETAILED DRAWINGS. CONTRACTOR TO PROVIDE AS IF DRAWN IN FULL. REPETITIVE FEATURES NOT INDICATED IN THE DRAWINGS EVERY PLACE THAT THEY OCCUR SHALL BE PROVIDED AS IF DRAWN IN FULL. DETAILS SHOWN ARE INTENDED TO BE INDICATIVE OF THE PROFILES AND TYPE OF DETAILING REQUIRED FOR THE WORK. DETAILS NOT SHOWN ARE SIMILAR IN CHARACTER TO THOSE DETAILED.
- 23. THE CONTRACTOR AND SUBCONTRACTORS SHALL CONSULT THE COMPLETE SET OF PLANS FOR COORDINATION OF WORK. THE CONTRACT DOCUMENTS ARE COMPLEMENTARY AND WHAT IS REQUIRED BY ONE SHALL BE BINDING AS IF REQUIRED BY ALL
- 24. EACH SUBCONTRACTOR SHALL VISIT THE SITE AND BECOME KNOWLEDGEABLE OF CONDITIONS THEREIN. EACH TRADE CONTRACTOR SHALL INVESTIGATE, VERIFY AND BE RESPONSIBLE FOR ALL THEIR REQUIREMENTS IN THE PROJECT AND SHALL NOTIFY THE ARCHITECT AND OWNER OF ANY CONDITIONS REQUIRING INFORMATION BEFORE PROCEEDING WITH THEIR WORK. THE SUBCONTRACTORS SHALL PROTECT ALL EXISTING SITE ELEMENTS FROM DAMAGE DUE TO CONSTRUCTION OPERATIONS AND REPAIR OR REPLACE ELEMENTS DAMAGED DURING THE PROJECT.
- 25. UNLESS NOTED OTHERWISE, ALL FASTENERS AND FASTENING DEVICES ARE TO BE CONCEALED IN ALL FINISHED SPACES. FASTENER SIZE AND SPACING SHALL BE IN ACCORDANCE WITH THE STRUCTURAL DRAWINGS AND FBC TABLE 2304.9.1. ALL FASTENERS FOR PRESERVATIVE-TREATED WOOD SHALL BE OF HOT-DIPPED ZINC-COATED GALVANIZED STEEL, STAINLESS STEEL, SILICON BRONZE OR COPPER IN ACCORDANCE WITH FRC R317.3.
- 26. ALL DISSIMILAR METALS SHALL BE EFFECTIVELY ISOLATED FROM EACH OTHER BY GASKETS OR COATINGS OR BOTH TO AVOID GALVANIC CORROSION ACTION.
- 27. ALL WOOD EXPOSED TO THE WEATHER SUCH AS DECKS, RAILINGS, JOISTS, BEAMS AND POSTS SHALL BE PRESSURE-TREATED. ALL WOOD IN CONTACT WITH CONCRETE OR MASONRY SHALL BE PRESSURE-TREATED.
- 28. EXPOSED SEALANTS SHALL BE CONSTRUCTED WITH A BOND BREAKER OR BACKER ROD. UNLESS NOTED OTHERWISE ALL EXTERIOR JOINTS SHALL BE SEALED WITH DOW CORNING 795 SILICONE SEALANT. HIDDEN SEALANT JOINTS NOT EXPOSED TO THE EXTERIOR SHALL BE BUTYL SEALANT.
- 29. PROVIDE BLOCKING AT ALL EXTERIOR WALL PENETRATIONS (HOSE BIBS, ELECTRICAL RECEPTACLES, FIXTURES, ETC.). PROVIDE A HEAD FLASHING OVER THE BLOCKING AT PENETRATIONS OVER 9" IN LENGTH.
- 30. PROVIDE BLOCKING FOR ALL CASEWORK, TOILET ACCESSORIES AND OTHER ELEMENTS MOUNTED TO OR BRACED AGAINST THE WALLS PRIOR TO INSTALLING

INDI	EX OF DRAWINGS
A0.1	COVER
A0.2	CODE SUMMARY, NOTES, INDEX OF DRAWINGS
A1.1	LIFE SAFETY PLAN - OVERALL FIRST FLOOR
A2.1	DEMOLITION PLAN - FIRST FLOOR - OVERALL
A2.2	DEMOLITION PLAN - FIRST FLOOR - WEST
A3.1	FLOOR PLAN - OVERALL
A3.2	FLOOR PLAN - WEST
A3.3	FLOOR PLAN - SOUTH
A4.1	REFLECTED CEILING PLAN
A7.1	SCHEDULES & INTERIOR ELEVATIONS
A9.1	SECTIONS AND DETAILS
E1.1	ELECTRICAL PLAN - OVERALL
E1.2	ELECTRICAL POWER PLAN - WEST
E1.3	ENLARGED ELECTRICAL PLANS

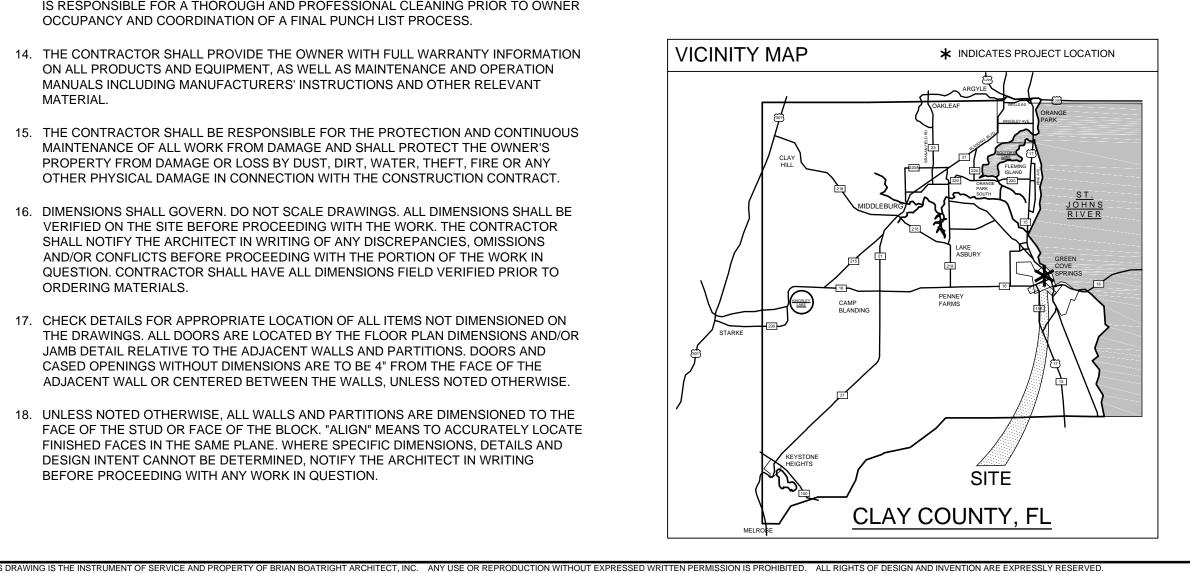

FLORIDA BUILDING CODE SUMMARY FLORIDA BUILDING CODES THIS IS AN EXISTING PUBLIC EDUCATION ANCILLARY PLANT/FACILITY USED FOR OCCUPANCY USE NARRATIVE: ADMINISTRATIVE PURPOSES. FBC, BUILDING (EXISTING CONSTRUCTION) **CHAPTER 3 - PROVISIONS FOR ALL COMPLIANCE METHODS** 301.1.1 COMPLIANCE METHOD CHAPTER 4 - PRESCRIPTIVE COMPLIANCE METHOD ALTERATIONS SHALL COMPLY WITH NEW BUILDING CODE **CHAPTER 5 - CLASSIFICATION OF WORK** ALTERATIONS - LEVEL 2 RECONFIG SPACE, ADDITION/DELETION OF DOORS OR WINDOWS NOTHING APPLICABLE TO THIS PROJECT **CHAPTER 7 - ALTERATIONS - LEVEL 1 CHAPTER 8 - ALTERATIONS - LEVEL 2** INCLUDE CHAPTER 7 ITEMS LEVEL 1 COMPLIANCE FBC, BUILDING (NEW CONSTRUCTION) **CHAPTER 3 - USE AND OCCUPANCY CLASSIFICATION** 304.1 BUSINESS - GROUP B OFFICES IN ANCILLARY PLANT/FACILITY **CHAPTER 4 - SPECIAL DETAILED REQUIREMENTS (SREF)** 453.3.2 OWNER REVIEW EXEMPT FROM LOCAL COUNTY PERMITTING, REVIEW & INSPECTION NOT A REUSE PROJECT 453.3.8 REUSE 453.4.2 FLOOD-RESISTANT CONSTRUCT NOT IN A FLOOD HAZARD AREA ASSEMBLY DEFINITION > 50 OCCUPANTS OCCUPANCY DURING CONSTRUCT SAFEGUARDS WILL BE FOLLOWED 453.6.1 453.7.1 SEPARATE EXITS PROVIDED EXISTING, ADJACENT TO EXITS 453.7.3 FIRE EXTINGUISHERS 453.7.4 FIRE ALARM **EXISTING** 453.7.5 FIRE ALARM SENDING STNS EXISTING, PULL STNS ADJACENT TO EXITS 453.7.6 AUTO SHUT-OFF **NOT REQUIRED** 453.7.7 UNOCCUP & CONCEALED SPACES EXISTING, DETECTORS PROVIDED 453.8.1.3 ANCILLARY FACILITY USE APPLICABLE OCCUPANCY IN CHAPTER 3 453.8.4 REMODELING/RENOVATION REMODELING SHALL BRING INTO COMPLIANCE 453.8.6 ASBESTOS PROHIBITED NONE SPECIFIED 453.8.8.5 CRIME PREVENTION GUIDELINES FOLLOWED 453.10.1 FENCING EXISTING 453.10.2.1 COVERED WALKS EXISTING 453.10.3.3 SITE LIGHTING **EXISTING** 453.13.6 HARDWARE PANIC BAR (EXIT DEVICES) PROVIDED 453.13.7.1 GLAZING TEMPERED PROVIDED IN ALL DOORS AND LOWER WINDOWS EXEMPT DUE TO SPACE PURPOSE 453.13.8.1 NATURAL LIGHT & VENTILATION **CHAPTER 5 - BUILDING HEIGHT AND AREA** ALLOWABLE BUILDING AREA (% TOTAL FOR EACH AREA): STORIES GROUPS ALLOWABLE SF 15 030* PROVIDED SF 13.663 *INCLUDES FRONTAGE INCREASE PER 506.3 (572'/621'=0.92-0.25=0.67) W/W = 0, SINCE 30' PROVIDED ON SEVERAL SIDES, AREA INCREASE = 6,030 **CHAPTER 6 - TYPE OF CONSTRUCTION** CONSTRUCTION TYPE V-B (NON-SPRINKLERED) (WORST CASE) **CHAPTER 7 - FIRE RESISTANT RATED CONSTRUCTION** FIRE WALLS NONE REQUIRED FIRE BARRIERS NONE REQUIRED **FIRE PARTITIONS** 708 NONE REQUIRED SMOKE BARRIERS NONE REQUIRED 710 SMOKE PARTITIONS NONE REQUIRED 711 FLOOR & ROOF ASSEMBLIES NONE REQUIRED 712 VERTICAL OPENINGS NOT APPLICABLE 713 SHAFT ENCLOSURES **NOT APPLICABLE NOT APPLICABLE** PENETRATIONS 715 JOINT SYSTEMS NOT APPLICABLE OPENING PROTECTIVES NOT APPLICABLE NOT APPLICABI F DUCTS & AIR XFER OPENINGS CONCEALED SPACES NOT APPLICABLE **CHAPTER 8 - INTERIOR FINISHES** INTERIOR EXIT PASSAGEWAYS CLASS A MIN CORRIDORS CLASS A MIN **CLASS C MIN** ROOMS **CHAPTER 9 - FIRE PROTECTION SYSTEMS** NO SPRINKLER SYSTEM REQUIRED 903.2.1.3 GROUP B **CHAPTER 10 - MEANS OF EGRESS** T1004.1.2 OCCUPANT LOAD (BUSINESS) FIRST FLOOR 11,098 SF/100 SF/OCC = 111 OCCUPANTS SECOND FLOOR 2,565 SF/100 SF/OCC = 26 OCCUPANTSTOTAL OCCUPANT LOAD EGRESS WIDTH 0.02"/OCC (SEE 1017.2, MIN. WIDTH TO BE 36") NUMBER OF EXITS T1006.2.1 2 REQUIRED (OL > 49) 75 FT MAX (OL > 30) COMMON TRAVEL DISTANCE 1008.1 EGRESS ILLUMINATION PROVIDED 1010.1.9.3 NOT REQUIRED (EXC 2: GROUP A, < 300 OCC) PANIC HARDWARE "DOOR TO REMAIN UNLOCKED" SIGNAGE REQUIRED 1010.1.9.3 SIGN REQUIRED

NOT APPLICABLE

NOT APPLICABLE

NONE (20 FT MAX)

NOT REQUIRED

NOT APPLICABLE

MECHANICAL

NONE

200 FT MAX

WILL PROVIDED AS REQUIRED

36 INCHES (OCCUP LOAD < 50)

NOT REQUIRED (NOT SERVED BY OL > 30)

NOT REQUIRED (NO ASSEMBLY SPACES)

SEE WIND DESIGN DATA ON THIS SHEET

SEE THE ACCESSIBILITY CODE SUMMARY BELOW

W/C LAVS FOUNT SVC SINKS

1011

1012

1013

1016.2.2

T1017.2

T1020.1

T1020.2

1020.4

1024

1028

1029

T403.1

STAIRWAYS

EXIT SIGNS

EXIT TRAVEL DISTANCE

MIN CORRIDOR WIDTH

DEAD END CORRIDORS

LUMINOUS PATHWAY

ASSEMBLY EGRESS

EMERGENCY ESCAPE

FLORIDA BUILDING CODE, PLUMBING

CHAPTER 4 - FIXTURES, FAUCETS AND FIXTURE FITTINGS 403.1 MIN NO. OF FIXTURES - BUSINESS OCCUPANCY

1/100

1/25 FOR 1ST 50, THEN 1/50

1/40 FOR 1ST 80, THEN 1/80

LAVS FOUNT SVC SINKS

REQUIRED

FAMILY (UNI-SEX) ALLOWED UNISEX ALLOWED IN LIEU OF SEPARATE FACILITIES

REQUIRED AT ENTRY

REQUIRED

FLORIDA PLUMBING CODE 2017 (6th Ed)

CORRIDOR RATING

EGRESS THRU INTERV. SPACES ALLOWED

RAMPS

CHAPTER 11 - ACCESSIBILITY

ATTIC

CHAPTER 16 - STRUCTURAL

BUSINESS

FOUNTAINS

WOMEN

TOTALS

403.4.1 DIRECTIONAL SIGNAGE

UNISEX

SERVICE SINKS 1

SEPARATE FACILITIES

W/C

LAVS

CHAPTER 12 - INTERIOR ENVIRONMENT

VENTILATION:

ACCESSIBILITY CODE SUMMARY FLORIDA ACCESSIBILITY CODE 2017 (6th Ed) **CHAPTER 2 - SCOPING REQUIREMENTS** VERTICAL ACCESSIBILITY EMPLOYEE WORK AREAS ACCESS FOR APPROACH, ENTRY & EXIT 203.9 ACCESSIBLE ROUTES 206 AN ACCESSIBLE ROUTE IS PROVIDED ACCESSIBLE EGRESS ACCESSIBLE EGRESS IS PROVIDED PROVIDED ACCESSIBLE PARKING PASSENGER LOADING STAIRWAYS DRINKING FOUNTAINS HI/LO PROVIDED KITCHENS AND SINKS ACCESSIBLE 213.2 **TOILET AND BATHING ROOMS** ACCESSIBLE RESTROOMS PROVIDED SIGNS SHALL BE PROVIDED WHERE REQD 216 **TELEPHONES** 217 36" MAX HT, SIDE APPROACH PROVIDED 226.1 WORK SURFACES **CHAPTER 3 - BUILDING BLOCKS** CHANGES IN LEVEL ACCESSIBLE ROUTE MEETS CODE **CHAPTER 4 - ACCESSIBLE ROUTES** ALL ON ACCESSIBLE ROUTE MEET CODE DOORS **CHAPTER 7 - COMMUNICATION ELEMENTS AND FEATURES** SIGNS WHERE REQUIRED, SIGNS SHALL COMPLY FLORIDA FIRE PREVENTION CODE SUMMARY FLORIDA FIRE PREVENTION CODE, 2017 (6th EDITION) "1:" SIGNIFIES NFPA 1 & "101:" SIGNIFIES NFPA 101, AS AMENDED BY FLORIDA 1:CHAPTER 6 - CLASSIFICATION OF OCCUPANCY (NOTE: 101, CHAPTER 6 IDENTICAL AS BELOW) CLASSIF. OF OCCUPANCY BUSINESS 1:CHAPTER 20.13 - BUSINESS 20.13.3.2.1 EXITS & EXIT CORRIDORS WALL & CLG: CLASS A OR B 20.13.3.2.2 ALL OTHER SPACES WALL & CLG: CLASS B OR C 20.13.3.3.2 EXITS & EXIT CORRIDORS FLOORING: CLASS I OR II 20.13.3.3.3 ALL OTHER SPACES PER 12.5.8.2: RADIANT FLUX MIN 0.1 W/CM² 101:CHAPTER 7 - MEANS OF EGRESS EXISTING FLOOR LEVEL PERMITTED TO BE 8" BELOW INT FLOOR LEVEL 7.2.1.3.5 SEE FBC BUILDING CODE SUMMARY - CHAPTER 10 T7.3.1.2 MIN. EXIT WIDTH 7.3.4.1(2) 7.4.1.1 MIN. NO OF EXITS 2 (< 500 OL) EXIT DIAGONAL SEPARATION EXISTING EXEMPT AS LONG AS REMOTE FROM EACH OTHER 7.5.1.3.5 7.8.1.2 EXIT ILLUMINATION REQUIRED DURING TIMES OF OCCUP. 101:CHAPTER 13 - EXISTING ASSEMBLY OCCUPANCIES 13.1.5 CLASS OF HAZARD ORDINARY AND LOW 13.1.7 OCCUPANT LOAD **SEE T7.3.1.2 ABOVE** ALL EXISTING EXIT DOORS FROM ASSEMBLY SPACES HAVE 13.2.2.2.3 DOORS EXISTING OR NEW PANIC HARDWARE IN COMPLIANCE WITH THIS SECTION NUMBER OF EXITS < 600 OL, 2 EXITS PERMITTED 13.2.5.1.2 COMMON PATH OF TRAVEL 20 FT FOR ANY OL, 75 FT FOR < 50 OL DEAD-END CORRIDORS 13.2.5.1.3 20 FT MAX (NONE) 250 FT MAX (WITH FIRE SPRINKLER SYSTEM) 13.2.6.2(1) TRAVEL DISTANCE 13.2.8 **ILLUMINATION OF EGRESS** PROVIDED 13.2.9 **EMERGENCY LIGHTING** PROVIDED 13.2.10 EXIT MARKINGS PROVIDED CORRIDOR & STAIR FINISHES CLASS A OR B 13.3.3.2 13.3.3.3 ASSEMBLY AREA FINISHES CLASS A, B OR C (< 300 OL) 13.3.3.5 FLOOR FINISHES NO REQUIREMENTS FIRE ALARM EXISTING FIRE ALARM SYSTEM (< 300 OL) 13.3.4.1.1 13.3.5 EXTINGUISHMENT PORTABLE EXTINGUISHERS PROVIDED REMAINING CHAPTER 13 SECTIONS DO NOT APPLY (MORE FOR THEATERS, CONVENTION HALLS, ETC) 101:CHAPTER 43 - BUILDING REHABILITATION EACH AREA SHALL BE CLASSIFIED INDEPENDENTLY CLASSIFICATION OF WORK 43.1.3.2 REPAIRS WORK SHALL BE DONE USING LIKE MATERIALS 43.3.1.3 INT FINISH REQUIREMENTS NEW INTERIOR FINISHES SHALL MEET REQS FOR NEW CONSTRUCTION SHALL BE PERMITTED TO COMPLY WITH 7.2.2.2.1.1(3) STAIR RECONSTRUCTION



FL: AA26003151,AR12659,ID541

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FLORIDA

REVISIONS NO DATE COMMENT 1 5-27-20 ADD 1

191003 JOB NO. 5-9-2020 DATE DRAWN BY BOB CHECKED BY BOB

2017 FLORIDA BUILDING CODE, ACCESSIBILITY CODE (6TH ED)

ACCESSIBLE ROUTE:

- ACCESSIBLE ROUTE TO COMPLY WITH 206 AND 402.
- ACCESSIBLE MEANS OF EGRESS TO COMPLY WITH 207. PARKING SPACES TO COMPLY WITH 208 AND 502.
- WALK SURFACES TO COMPLY WITH 403.

ACCESSIBLE DOORS AND DOORWAYS: DOORS AND DOORWAYS TO COMPLY WITH 404.

 THRESHOLDS TO COMPLY WITH 404.2.5. DOOR HARDWARE TO COMPLY WITH 404.2.7.

ACCESSIBLE TOILET FACILITIES:

ACCESSIBLE TOILET FACILITIES TO COMPLY WITH 213 AND CHAPTER 6.

CONF 139

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OFFICE 137

DRINKING FOUNTAINS TO COMPLY WITH 602.

TOILET ROOMS TO COMPLY WITH 603.

ACCESSIBLE KITCHENS: ACCESSIBLE KITCHENS TO COMPLY WITH 212, 606, AND 804.



DIRECTIONAL AND INFORMATION SIGNAGE TO COMPLY WITH 216.

RESTRM RESTRM 154 153 OFFICE 156 CONFERENCE 152 EXIT DIST = 51'-3" 157 EXIT DIST RESTRM = 33'-10" 121 149 127B 127A EXIT DIST = 72'-7" OFFICE STOR 142 OFFICE 148 EXIT DIST 145 120 30 163 = 88'-5" EXIT DIST = 72'-2" YEXIT DIST = 59'-11" EXIT DIST = 38'-8" OFFICE 164 OFFICE 124 BREAK EXIT DIST 30 EXIT DIST = 49'-1" OFFICE 140 = 52'-8" OFFICE 141 CONF 131 OFFICE 136 OFFICE 134 OFFICE 129 OFFICE PLANS 127 133 OFFICE 118 OFFICE 125 EXIT DIST = 54'-8" EXIT DIST = 58'-8"

145

EXIT DIST = 85'-7"

OFFICE 128

OFFICE 130

OFFICE 132

- HATCHED AREA IS NOT IN THE SCOPE OF THIS PROJECT

EXIT DIST = 37'-3"

110E

EXIT DIST = 61'-3"

112A

107A

OFFICE 111

RRM 114

OFFICE 126

OFFICE 117

SYMBOLS → LONGEST EXIT PATH FIRE EXTINGUISHER BrianBoatrightArchitect.com brianoboatrightaia@gmail.com FL: AA26003151,AR12659,ID5414 FE-1 5-lb. (3A-40BC) FE-2 10-lb. (4A-80BC) FE-3 20-lb. (20A-120BC) FE-4 15-lb. (CLASS K)

1-HR RATED WALL

COMBINATION EXIT SIGN AND

EMERGENCY LIGHT

SMOKE DETECTOR HEAT DETECTOR

HORN/VOICE EVACUATION

STROBE/HORN, VOICE EVACUATION

FIRE ALARM ANNUNCIATOR PANEL FS FIRE SUPPRESSION FLOW SWITCH

TS FIRE SUPPRESSION TAMPER SWITCH

FIRE ALARM CONTROL PANEL

FIRE PULL

☑ STROBE

WE \Box **ERATIONS** DISTRICT

COVE

GREEN

CENTER

REVISIONS NO DATE COMMENT 1 5-27-20 ADD 1

191003 JOB NO. 5-9-2020 DATE DRAWN BY BOB CHECKED BY BOB

AREA CALCULATIONS

SECOND FLOOR TOTAL AREA (GROSS)

11,098 GSF

2,565 GSF 13,663 GSF

FIRST FLOOR

A1.1

) LIFE SAFETY PLAN - OVERALL FIRST FLOOR

OFFICE 103

OFFICE 106

EXIT DIST **4** = 48'-0"

101

OFFICE 105

END

WE

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RATIONS

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REVISIONS


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5-9-2020

COVE

GREEN

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REFER TO SHEET A3.1 FOR TABLE OF WORK SCOPE FOR ADDITIONAL INFORMATION ON WORK IN THIS AREA.

BE FIELD VERIFIED. NO WARRANTY IS GIVEN FOR THE ACCURACY OF EXISTING CONDITIONS. NOTIFY THE ARCHITECT OF ANY DISCREPANCIES.

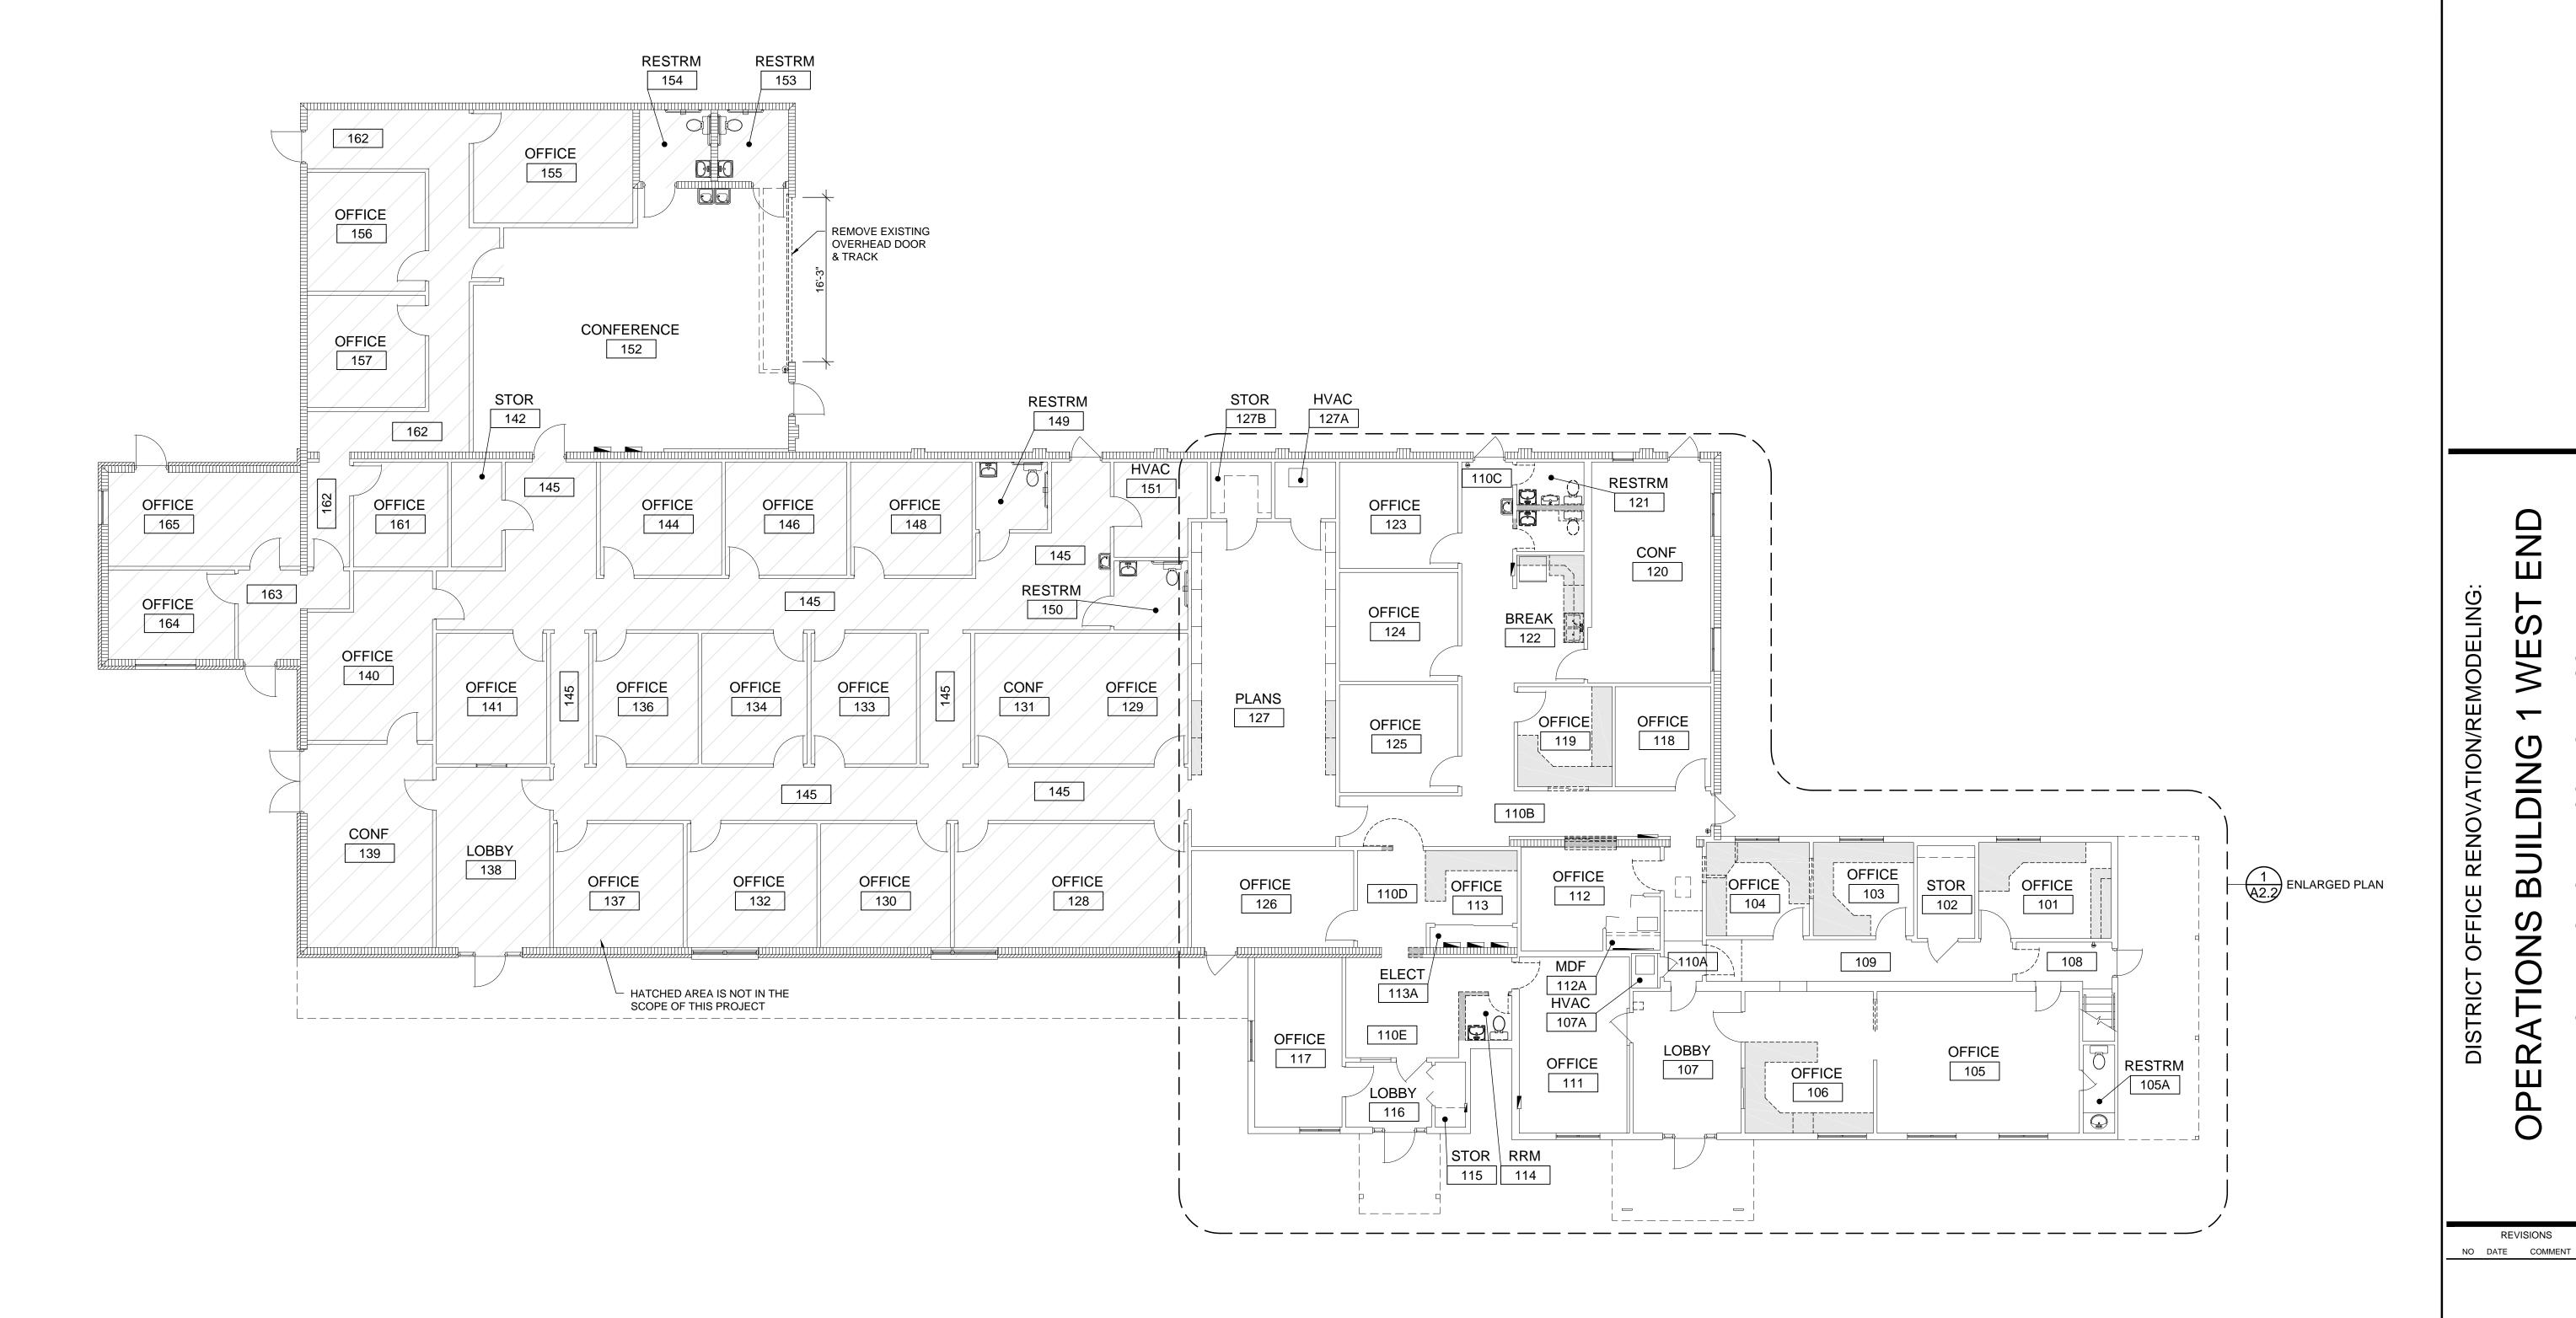
A2.1

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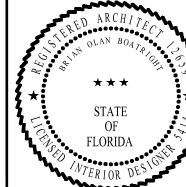
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DATE



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OPERATIONS BUILDING 1 WEST END

DISTRICT

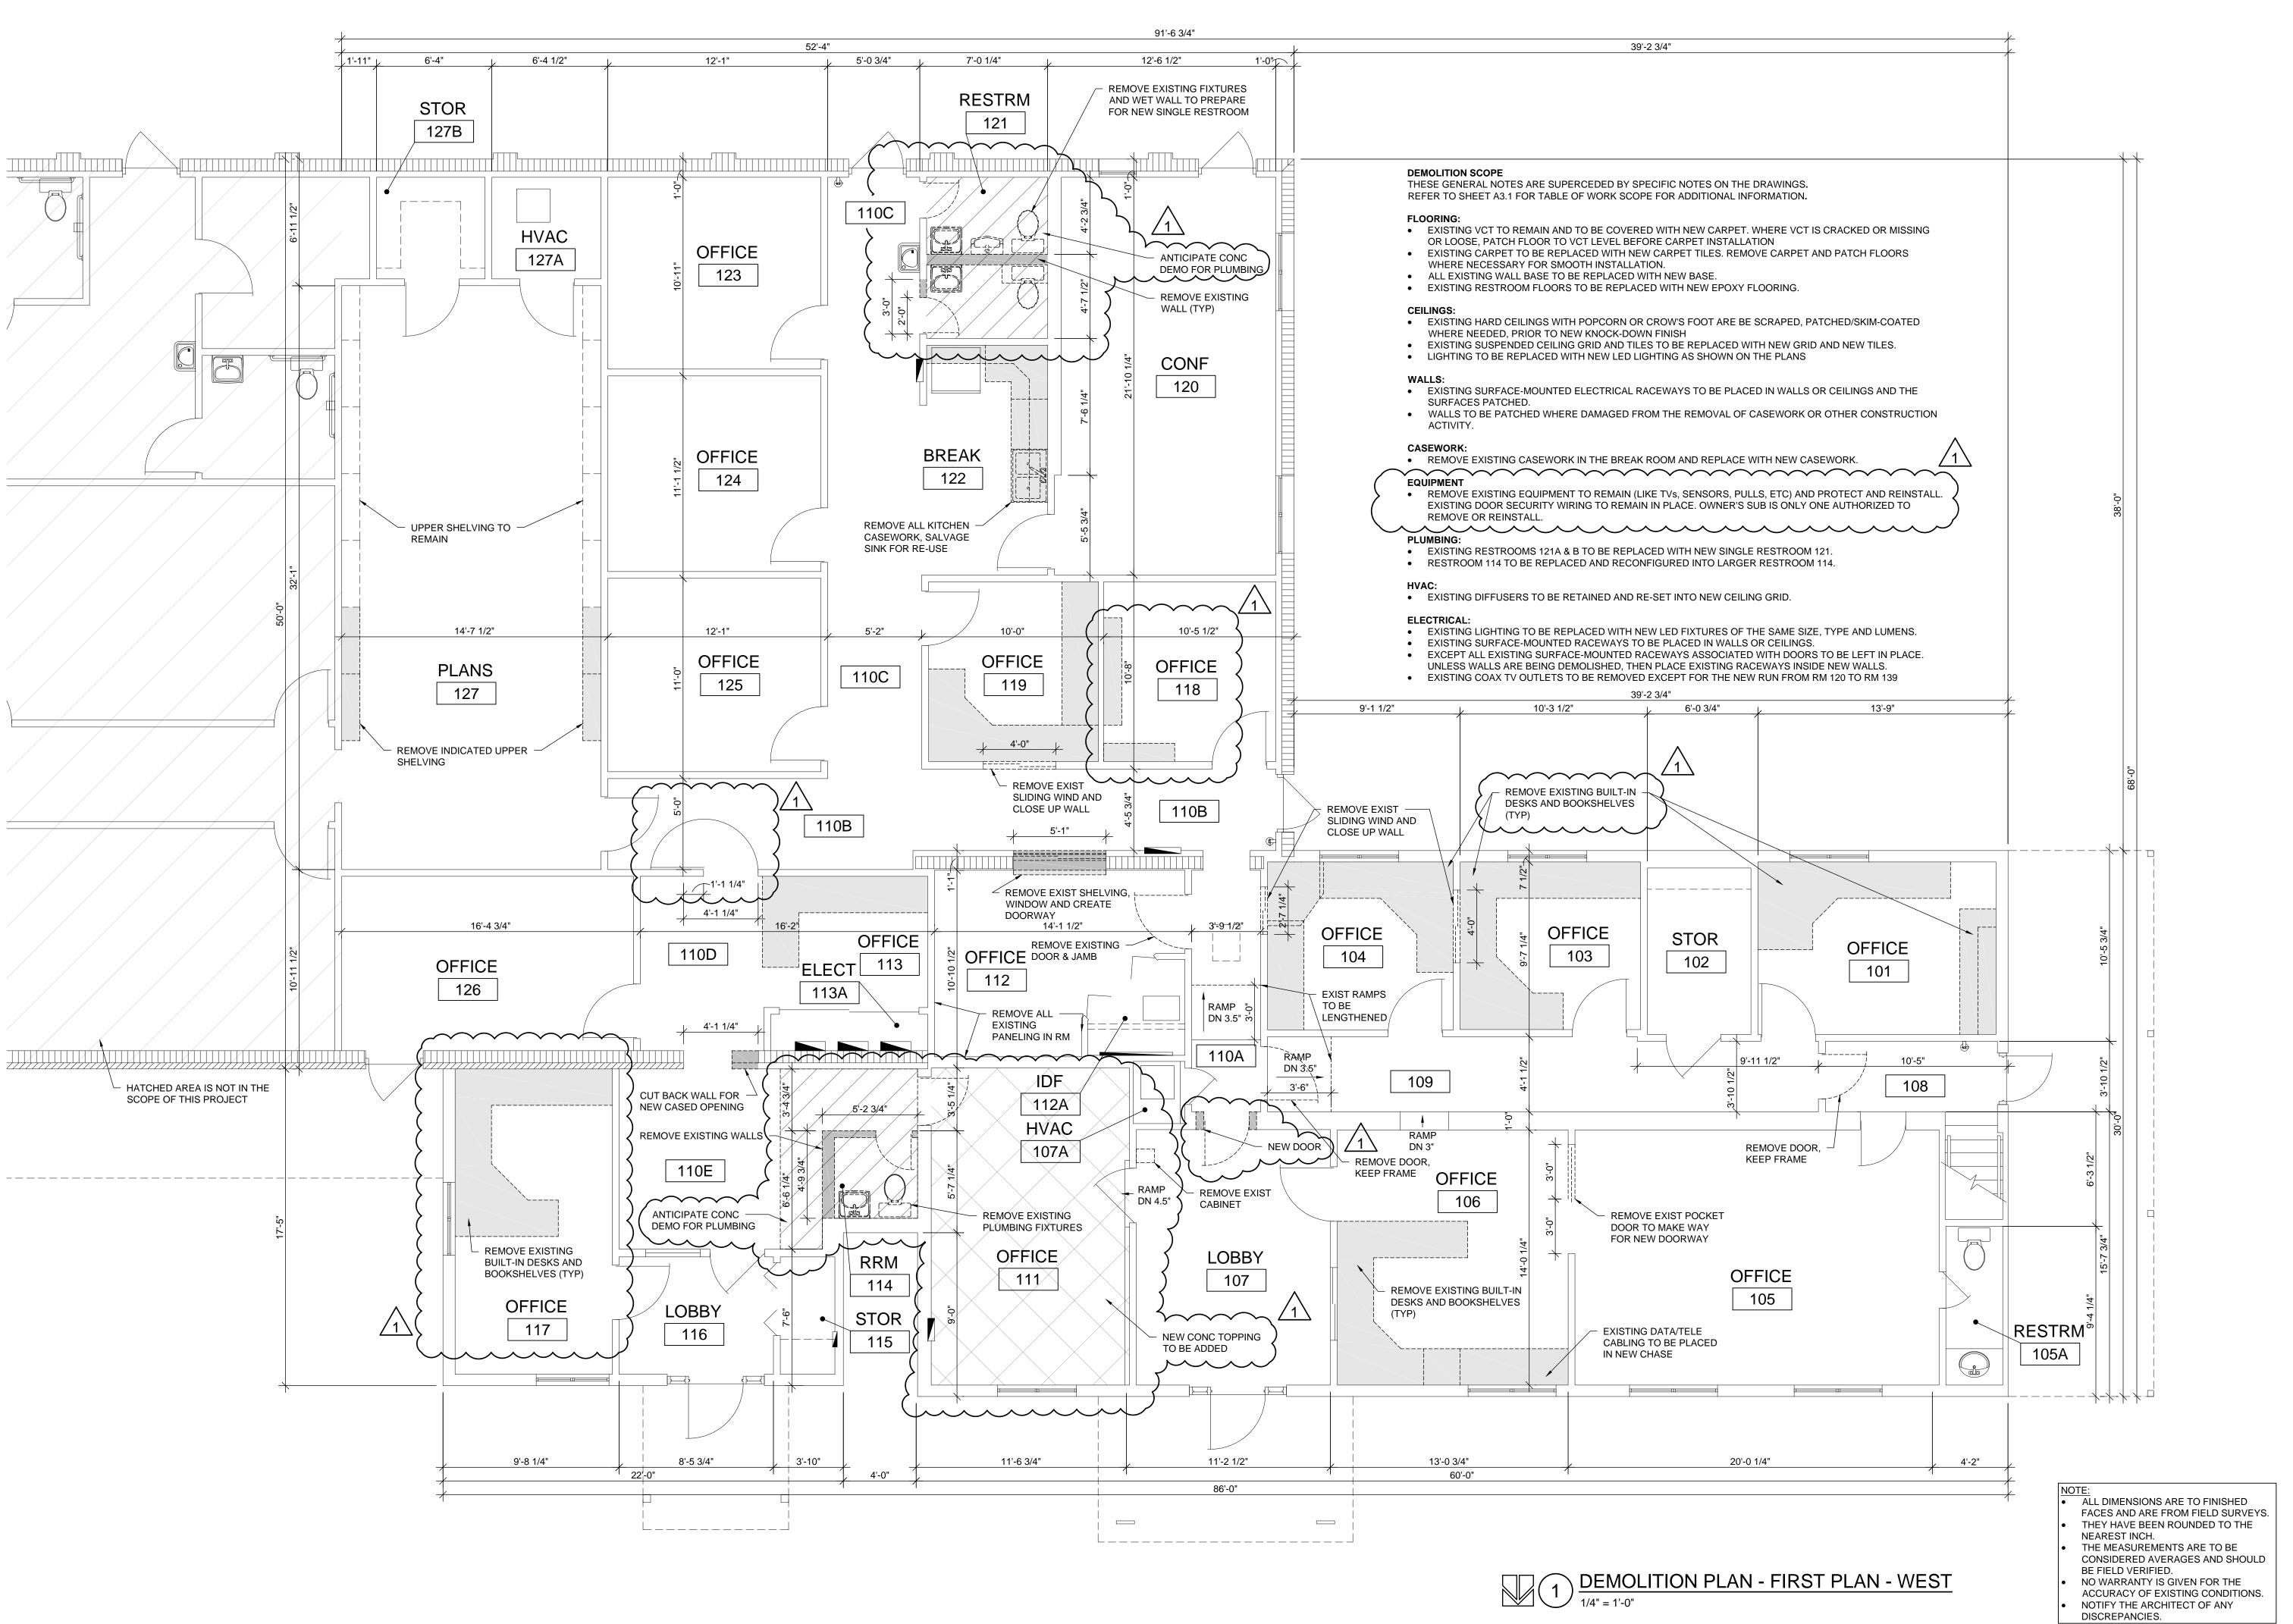COVE

GREEN

CENTER

 REVISIONS

 NO
 DATE
 COMMENT

 1
 5-27-2020
 ADD 1

NO. 191003 5-9-2020


JOB NO. 191003

DATE 5-9-2020


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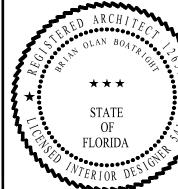
A2.2



ĀRCHITEC 914 PIAINFIEID AVENUE ORÂNGE PARK, FL 32073 CONTACT: 904 413 8028 BrianBoatrightArchitect.com brianoboatrightaia@gmail.com FI: AA26003I 51,AR12659,ID5414

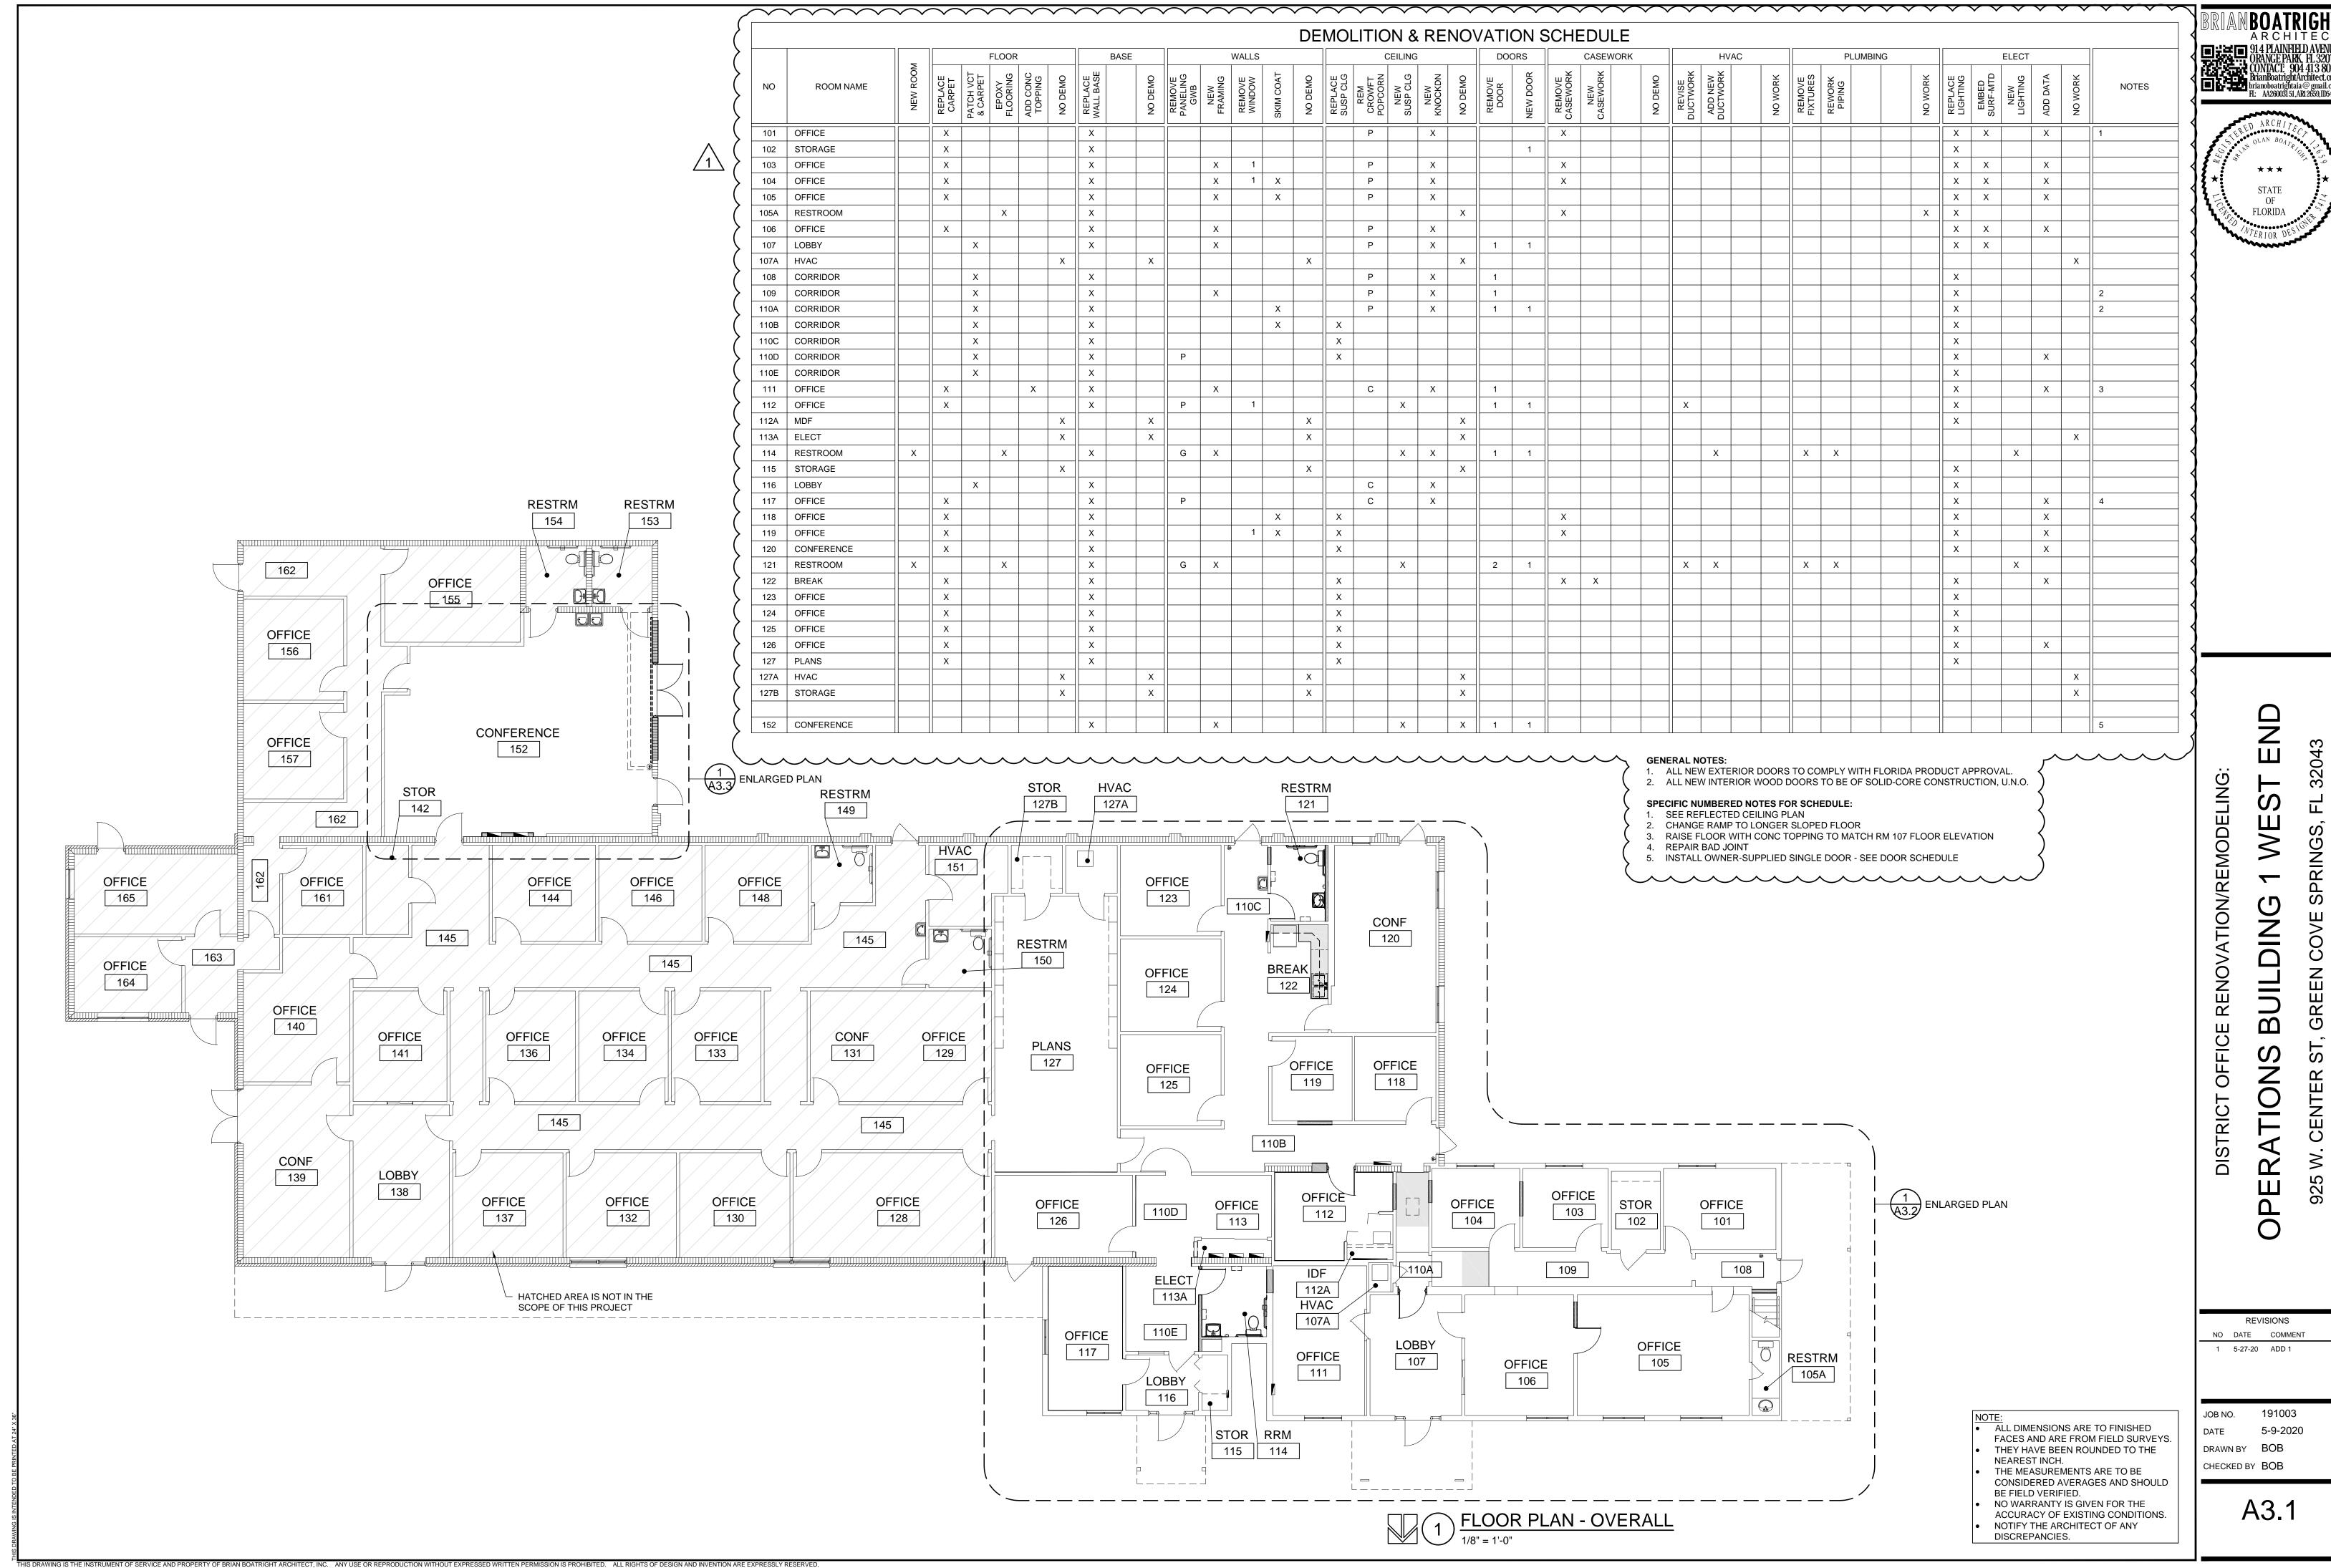


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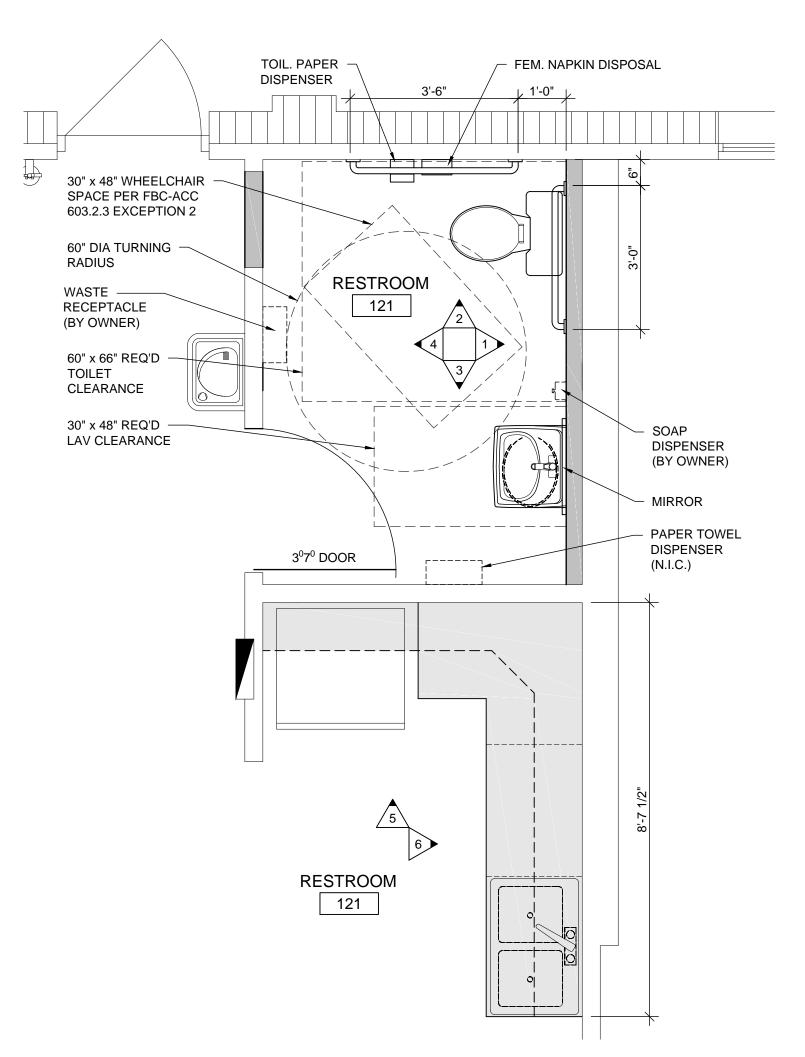


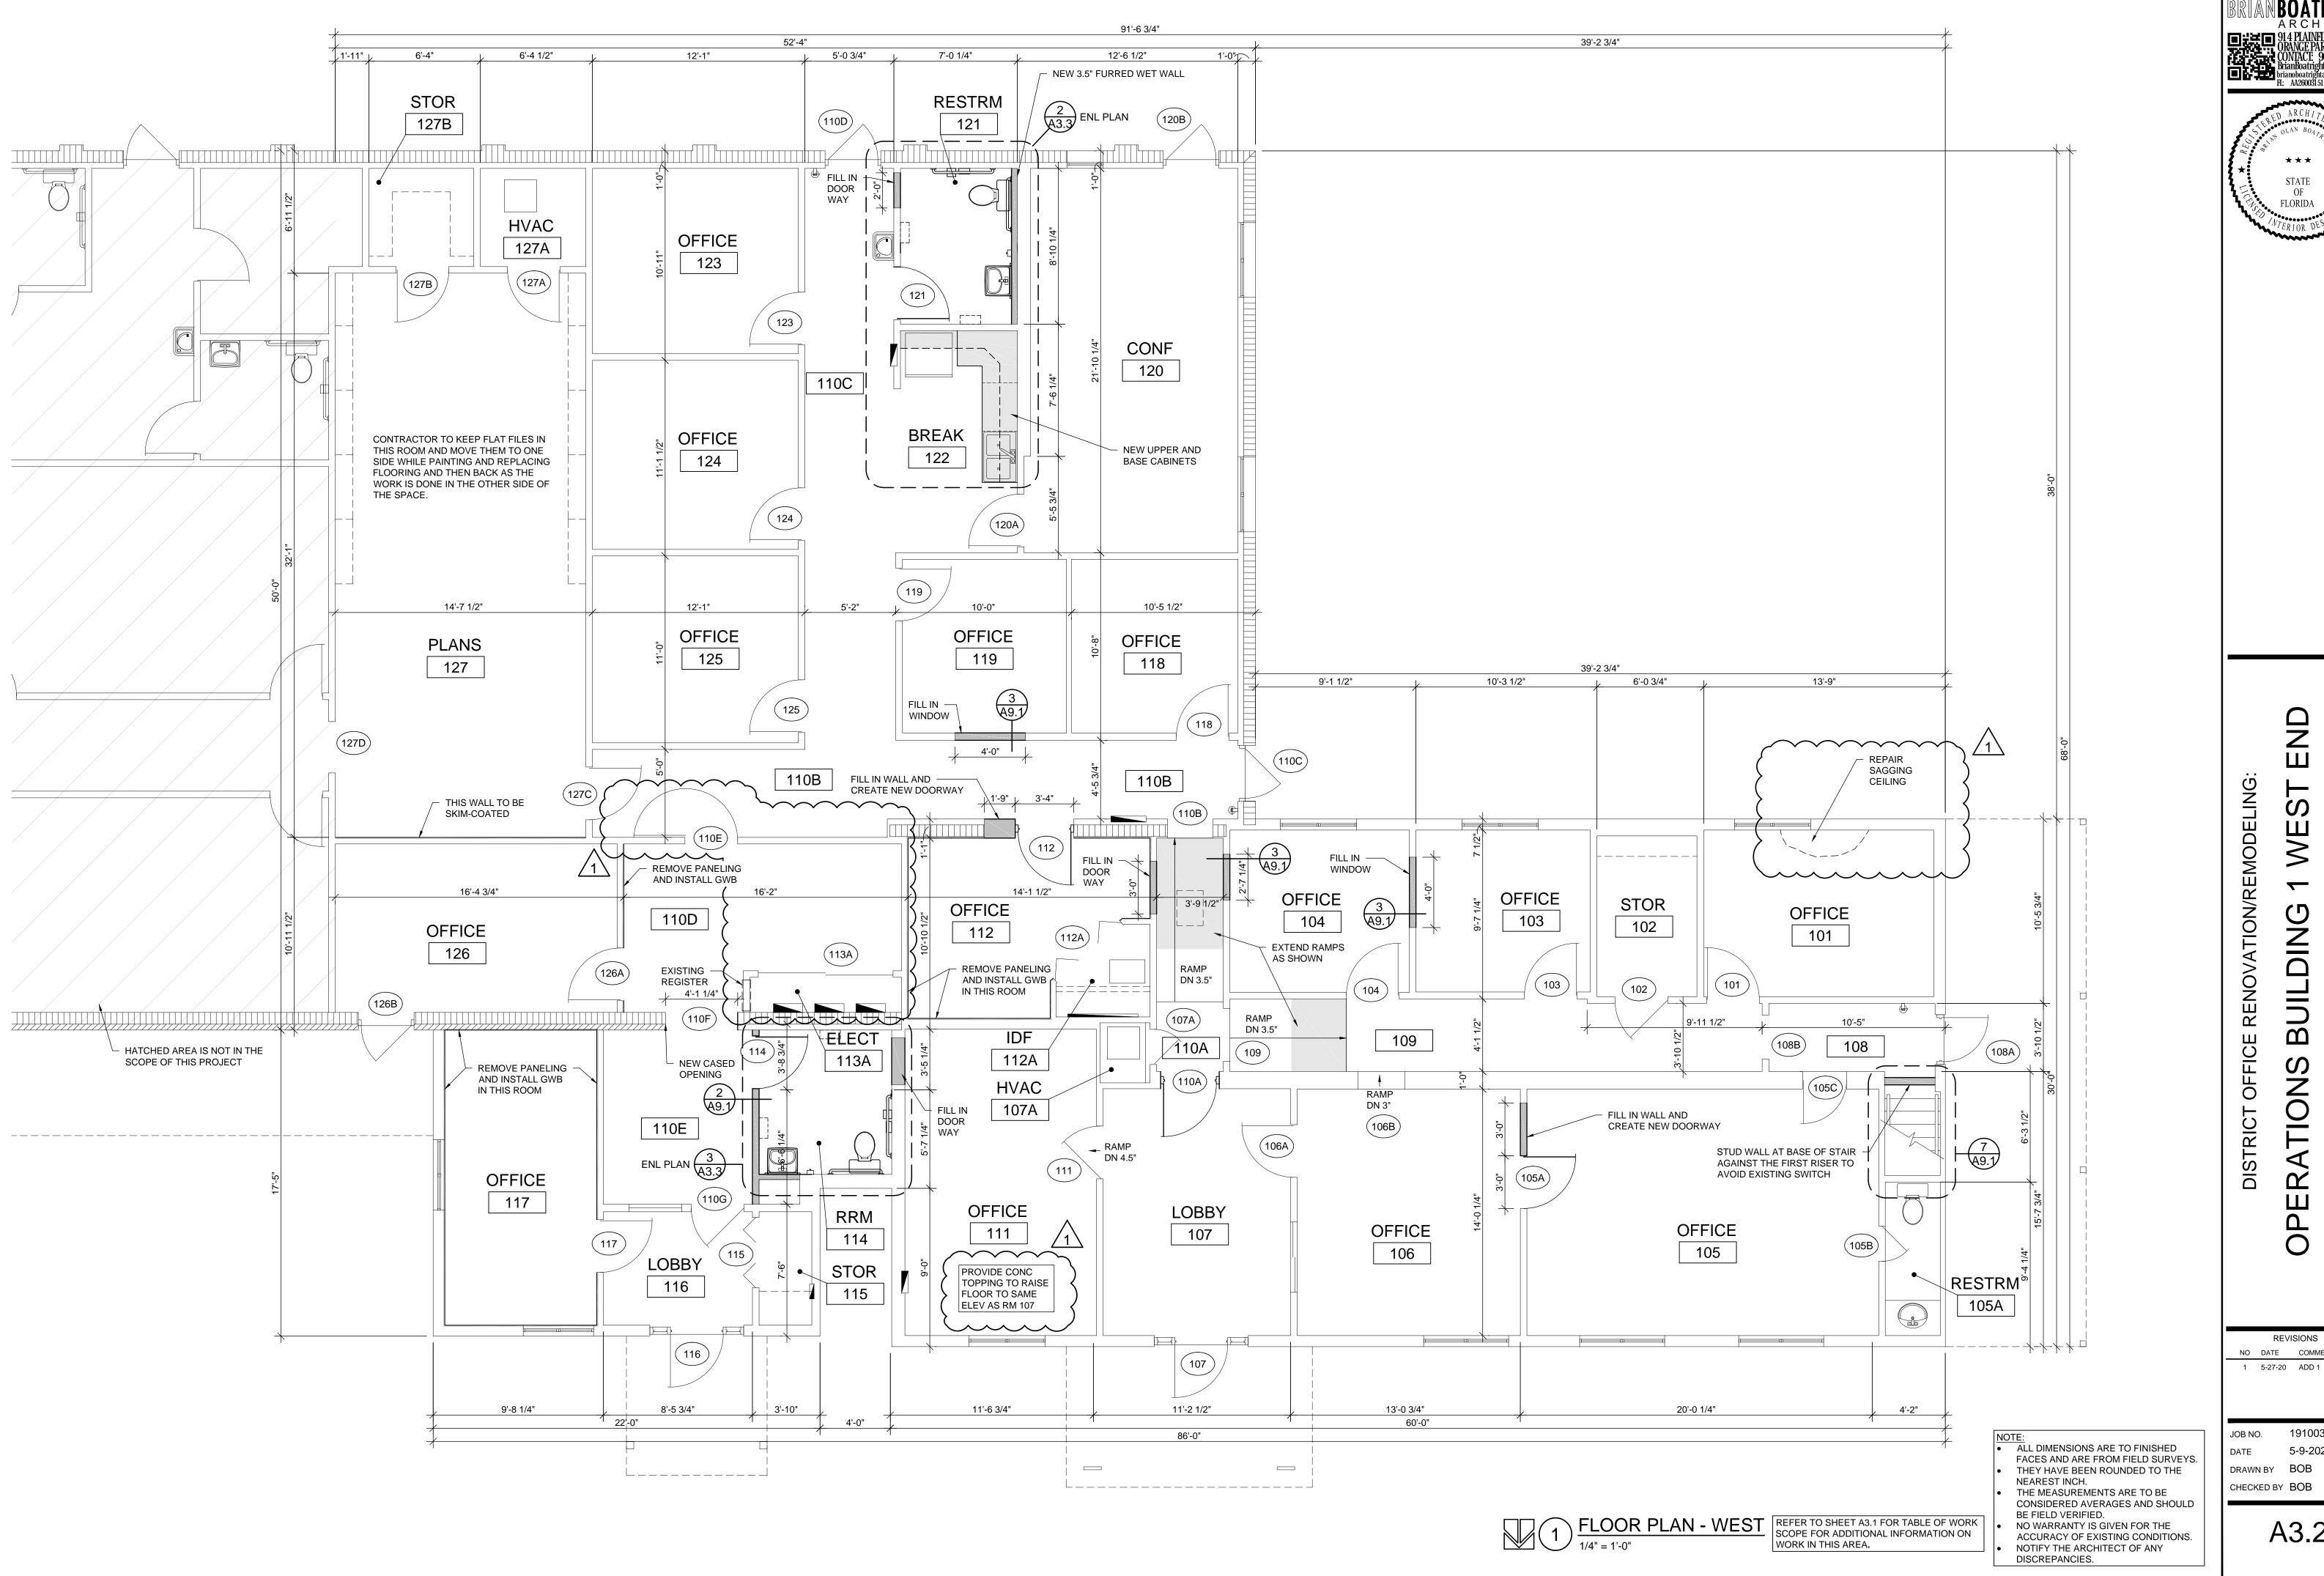SPRINGS, COVE GREEN S CENTER 925


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191003 5-9-2020 DRAWN BY BOB



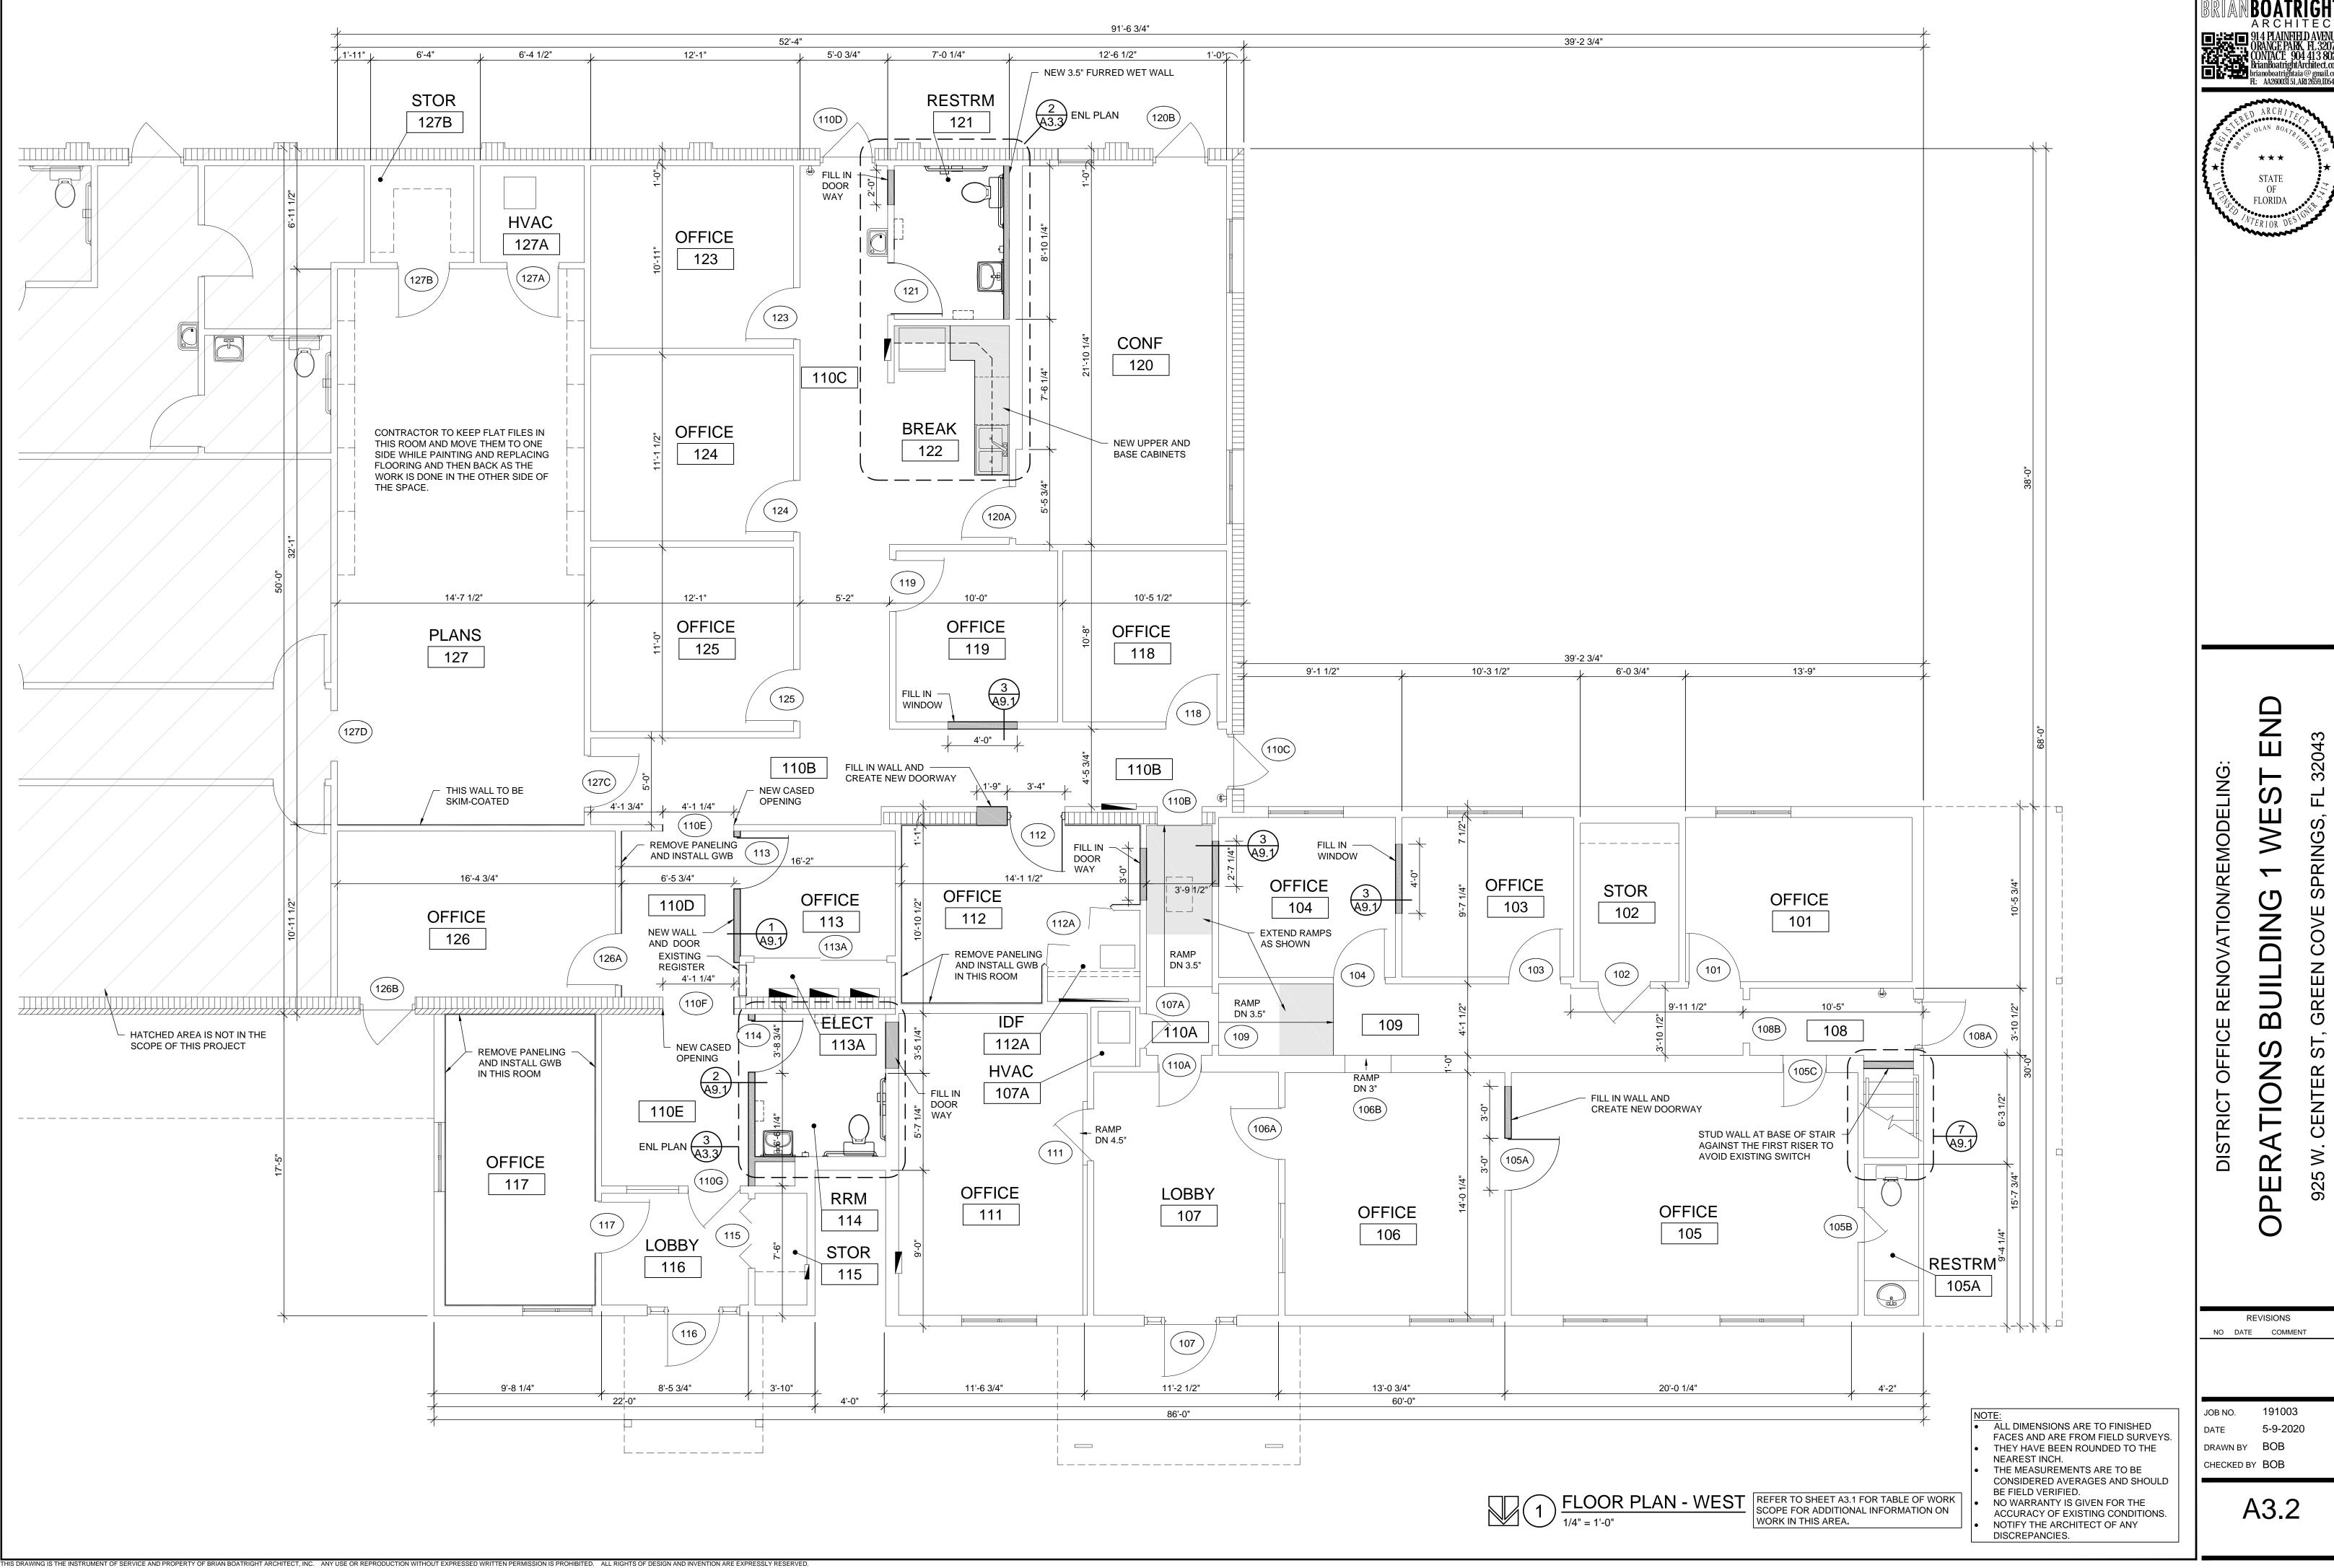

2) ENLARGED RESTROOM 121 & BREAK AREA 122

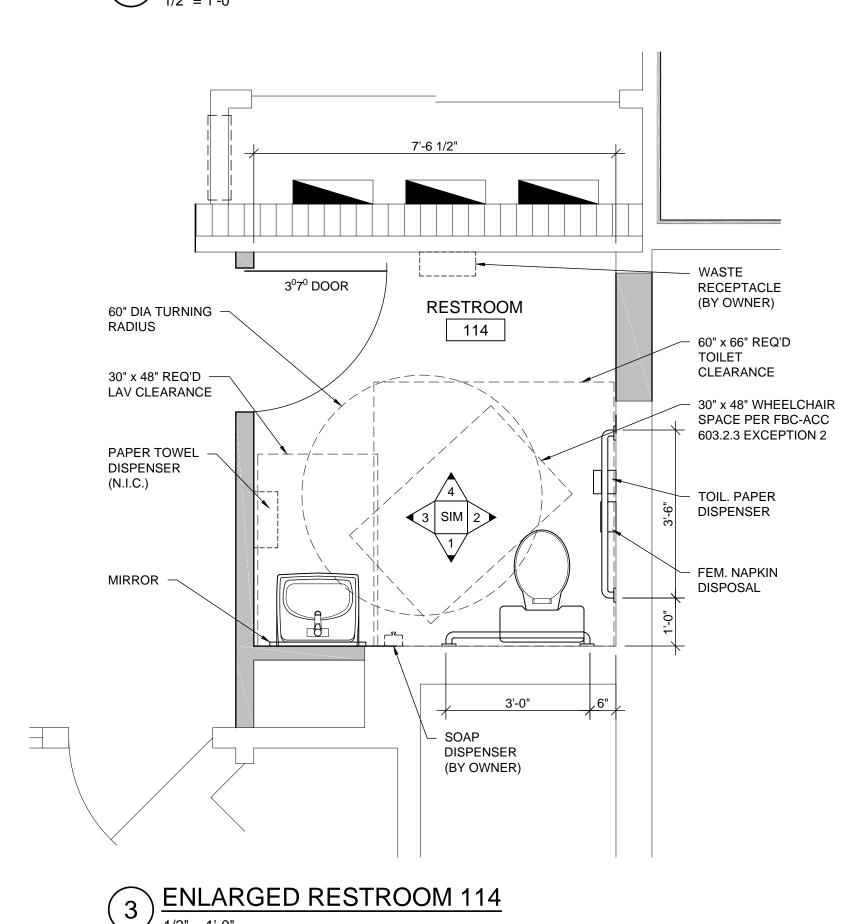

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NOTE:


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THEY HAVE BEEN ROUNDED TO THE NEAREST INCH.


THE MEASUREMENTS ARE TO BE CONSIDERED AVERAGES AND SHOULD BE FIELD VERIFIED.

NO WARRANTY IS GIVEN FOR THE ACCURACY OF EXISTING CONDITIONS.

NOTIFY THE ARCHITECT OF ANY DISCREPANCIES.

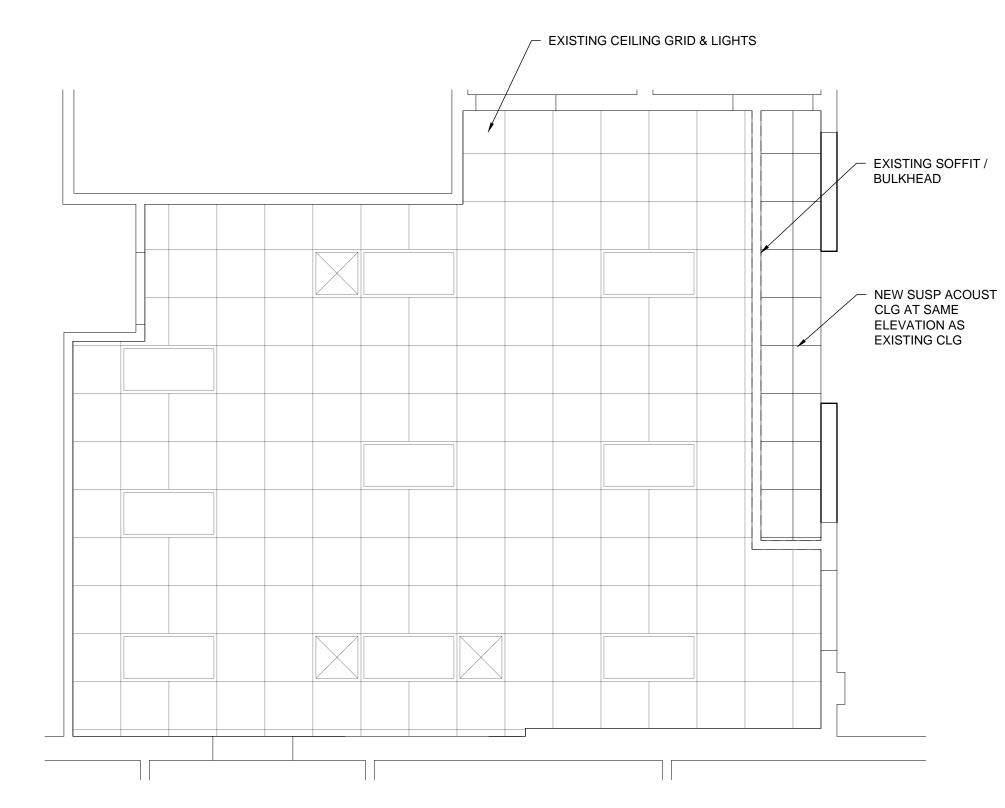

 $4 \frac{\text{REFLECTED CEILING PLAN - ROOM 152}}{\frac{1}{4} = 1'-0"}$

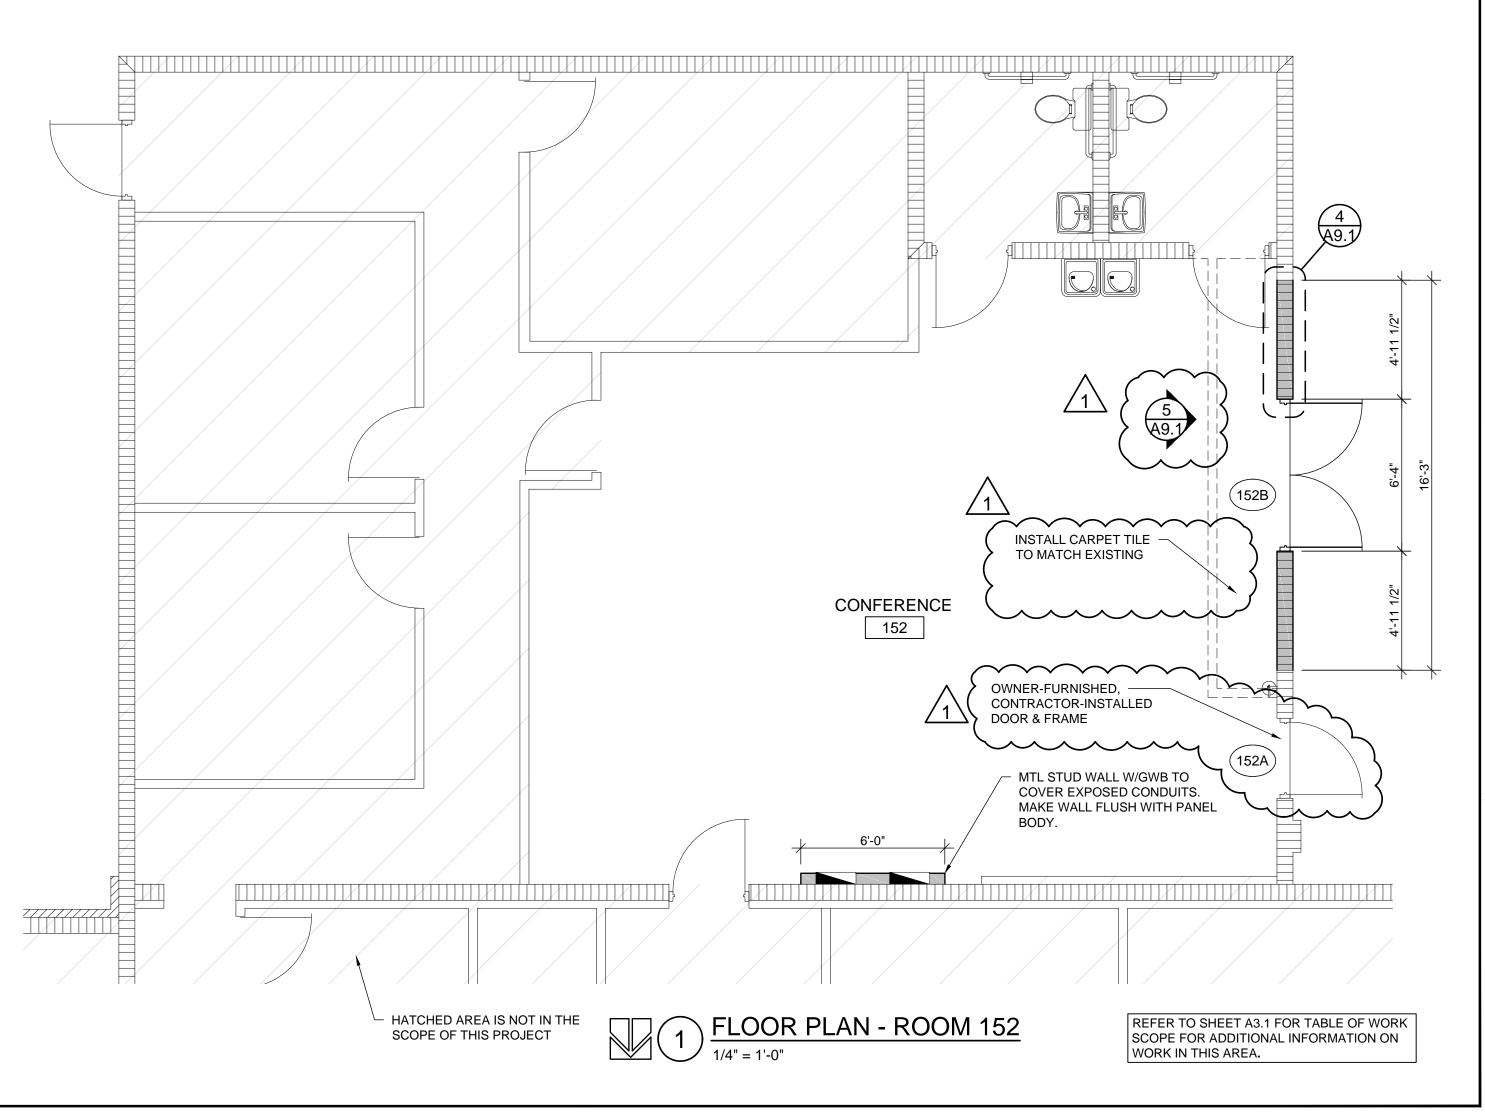

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STATE
OF
FLORIDA

WTERIOR DESIGNATION

DISTRICT OFFICE RENOVATION/REMODELING: RATIONS BUILDING 1 WEST END

SPRINGS,

COVE

GREEN

CENTER

REVISIONS

NO DATE COMMENT

1 5-27-20 ADD 1


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DATE 5-9-2020


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A3.3



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SPRINGS,

COVE

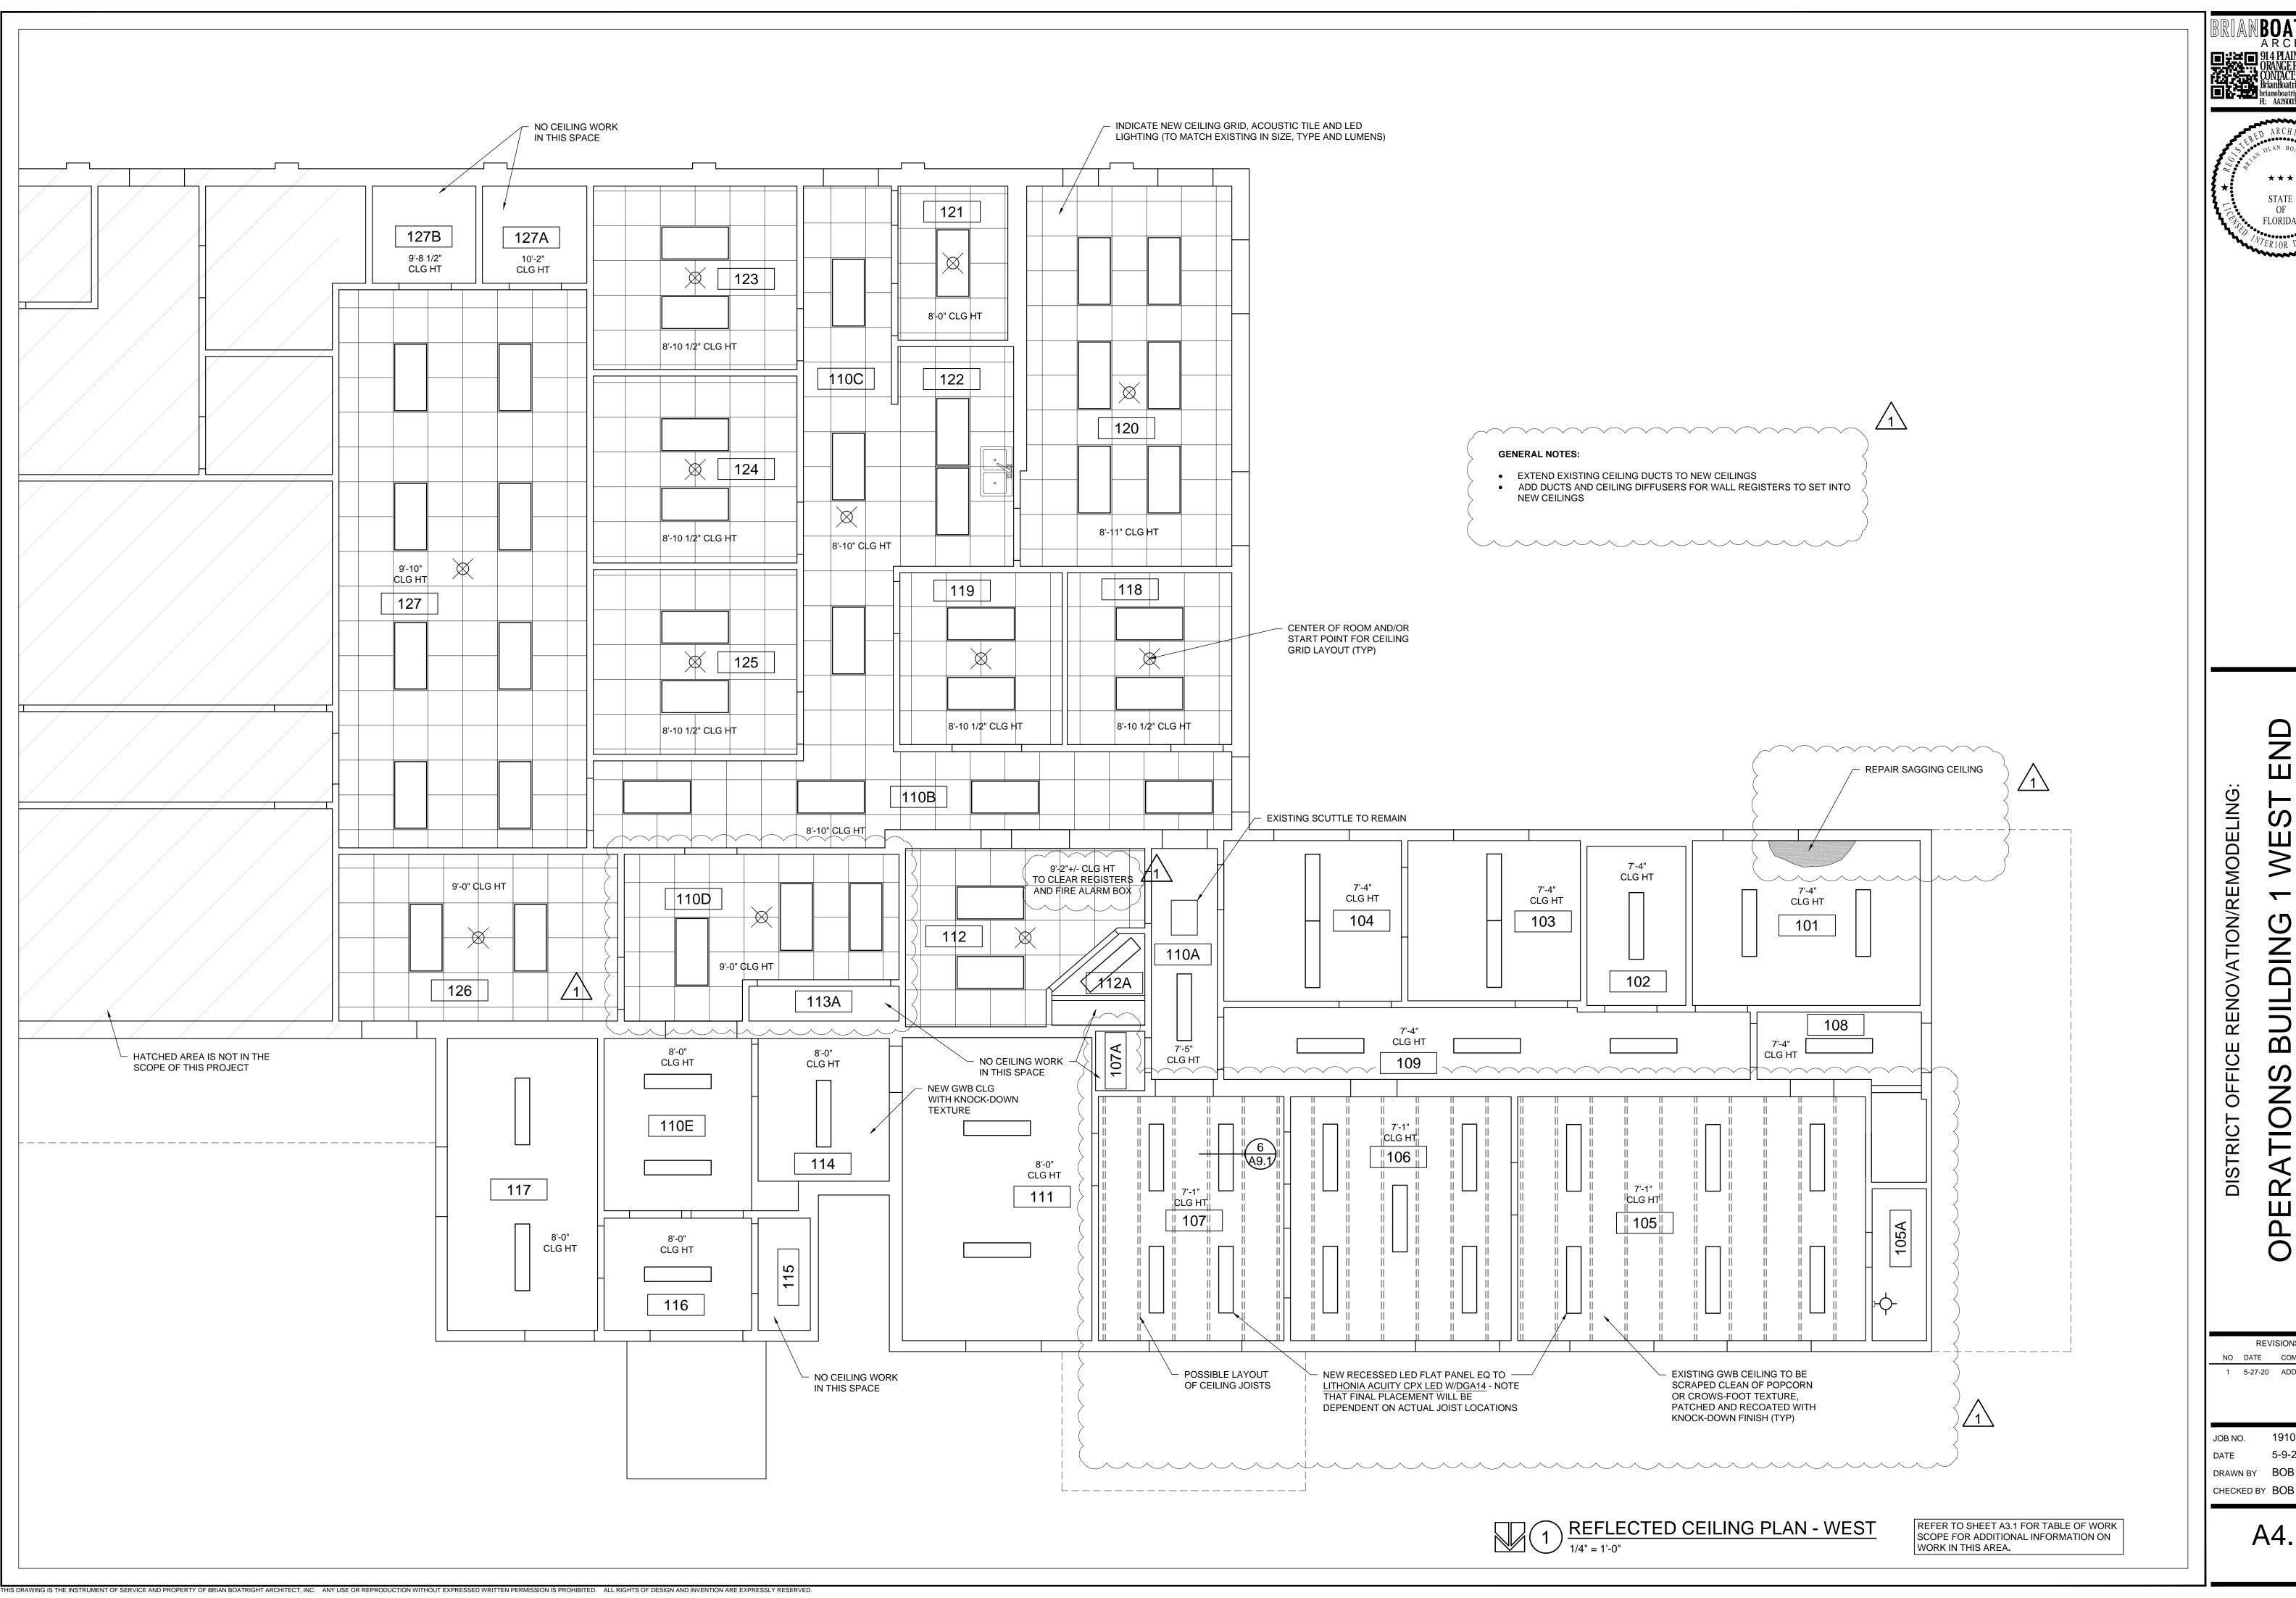GREEN

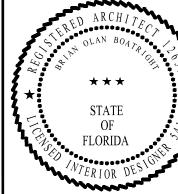CENTER

JOB NO. 191003

5-9-2020 DRAWN BY BOB CHECKED BY BOB

			FLOOR			BASE		WALLS				CEILING	}		IEW	
NO	ROOM NAME	CARPET TILE	ЕРОХҮ	NO WORK	RUBBER	NO WORK	NEW GWB	SKIM COAT	PAINT	NO WORK	KNOCK-DN GWB	SUSPENDED	NO WORK	CLG HT	EXISTING OR NEW	NOTES
101	OFFICE	X			X				Х		X			7'-4"	E	
102	STORAGE	Х			Х				Х		Х			7'-4"	Е	
103	OFFICE	Х			Х			Х	Х		Х			7'-4"	Е	
104	OFFICE	X			Х			Х	Х		Х			7'-4"	Е	
105	OFFICE	Х			Х				Х		Х			7'-1"	Е	
105A	RESTROOM			Х		Х				Х			Х	7'-4"	Е	
106	OFFICE	X			Х				Х		X			7'-1"	Е	
107	LOBBY	X			Х				Х		Х			7'-1"	E	
107A	HVAC			Х		Х				Х			Х	N/A	Е	
108	CORRIDOR	X			Х		Х		Х		X			7'-4"	E	
109	CORRIDOR	X			Х				Х		X			7'-4"	Е	
110A	CORRIDOR	X			Х		Х	Х	Х		X	Х		VARIES	E	
110B	CORRIDOR	X			Х		Х	Х	Х		X	Х		VARIES	N	
110C	CORRIDOR	X			Х		Х	Х	Х		X	Х		VARIES	N	
110D	CORRIDOR	X			Х		Х		Х		X	Х		VARIES	N	
110E	CORRIDOR	X			Х		Х	Х	Х		X	Х		VARIES	E	
111	OFFICE	X			Х				Х		X			8'-0"	E	
112	OFFICE	X			Х		Х		Х			Х		9'-0"	N	
112A	IDF			Х	Х				Х				Х	N/A	E	
113A	ELECTRICAL			Х		Х				Х			Х	N/A	E	
114	RESTROOM		Х		X		X		Х		X			8'-0"	N	
115	STORAGE	X			X					Х			Х	8'-0"	E	
116	LOBBY	X			X				Х		X			8'-0"	E	
117	OFFICE	X			X		X		X		X			8'-0"	E	
118	OFFICE	X			X			_	X			X		8'-10.5"	N	
119	OFFICE	X			X			Х	X			X		8'-10.5"	N	
120	CONFERENCE	X	_		X				X			X		8'-11"	N	
121	RESTROOM		Х		X		X		X			X		8'-0"	N	
122	BREAK AREA	X			X				X			X		8'-10"	N	
123	OFFICE	X			X				X			X		8'-10.5"	N	
124	OFFICE	X			X				X			X		8'-10.5"	N	
125	OFFICE	X			X				X			X		8'-10.5"	N	
126	OFFICE	X			X				X			X		9'-0"	N	
127	PLANS	X			X				Х			Х	,,,	9'-10"	N	
127A	HVAC			X		X				X			X	N/A	E	
127B	STORAGE			X		X				X			X	N/A	E	
152	CONFERENCE	X			X		X		X			X			E	1
104	JOIN LINEINOL															<u> </u>

PENTZ MODULAR COMMERCIAL CARPET TILE REVIVAL

EPOXY FINISH - TO BE SELECTED FROM STANDARD COLOR

BURKE RUBBER UNI-COLOR #875 "NAVY (NIGHT BLUE)"

PAINT, SHERWIN-WILLIAMS, SW 7661 "REFLECTION" FRAMES PAINT, SHERWIN-WILLIAMS, SW 7665 "WALL STREET"

GWB-1 LEVEL 4, KNOCK-DOWN FINISH

TO LEVEL 4 AND PAINTED SMOOTH.

1. PARTIAL NEW GRID

GENERAL DOOR & WINDOW NOTES: . ALL EXTERIOR DOORS & WINDOWS TO HAVE

CURRENT FLORIDA PRODUCT APPROVALS ALL WINDOWS SHALL MEET AAMA 101.

ALL DOOR GLASS TO BE TEMPERED. SEE PLANS FOR QUANTITIES.

FIELD VERIFY ALL SIZES BEFORE ORDERING. SIZES ON THE PLANS ARE NOMINAL AND INTENDED TO CONVEY DESIGN INTENT. VERIFY SIZES WITH MANUF. AND FIELD CONDITIONS AND PROVIDE REQUIRED ROUGH OPENING TO ENSURE

PROPER INSTALLATION. PROVIDE WEATHERSTRIPPING & DOOR SWEEPS TO ALL EXTERIOR DOORS. PROVIDE NON-EXPANDING SEALANT AT ALL DOORS,

WINDOWS AND ROOF PENETRATIONS. . FLASH ALL WINDOWS PER AAMA 2400, AND PROVIDE SILL PANS PER ASTM E2112.

UNLESS NOTED OTHERWISE, ALL DIMENSIONS ARE ROUGH OPENING SIZES AND NOT INCLUDING SHIM SPACE

(XXX)

EXISTING SIZE REPLACE HARDWARE NO ROOM NOTES DOOR TO CHANGE GROUP | CHANGE | LOCKSET $W \times H$ REMAIN MATERIAL FINISH MARK TYPE MATERIAL FINISH YES YES $3^{0} \times 7^{0}$ RESTROOM YES YES YES YES $2^6 \times 7^0$ YES YES $3^{0} \times 7^{0}$ $2^8 \times 7^0$ YES YES YES $3^{0} \times 7^{0}$ $2^6 \times 7^0$ CORRIDOR CORRIDOR YES $2^6 \times 7^0$ WOOD YES CO YES YES YES $3^{0} \times 7^{0}$ STEEL FLUSH $2^6 \times 7^0$ YES YES CORRIDOR $3^{0} \times 7^{0}$ YES OFFICE $3^{0} \times 7^{0}$ 1 3/8 STEEL ELECTRICAL YES $3^{0} \times 7^{0}$ RESTROOM $3^{0} \times 7^{0}$ STORAGE YES $3^0 \times 7^0$ YES $3^{0} \times 7^{0}$ Χ YES $3^{0} \times 7^{0}$ OFFICE YES OFFICE YES $3^{0} \times 7^{0}$ YES YES $3^{0} \times 7^{0}$ OFFICE YES 4 $3^0 \times 7^0$ YES YES CONFERENCE YES $3^0 \times 7^0$ CONFERENCE RESTROOM YES $3^{0} \times 7^{0}$ 1 3/8 || HM STEEL PAINT FLUSH $3^{0} \times 7^{0}$ YES YES OFFICE 4 YES YES $3^{0} \times 7^{0}$ OFFICE $3^{0} \times 7^{0}$ YES YES 4 YES YES $3^{0} \times 7^{0}$ YES $3^{0} \times 7^{0}$ OFFICE $3^{0} \times 7^{0}$ YES YES YES YES $3^{0} \times 7^{0}$ STORAGE 5 YES YES $3^{0} \times 7^{0}$ PLANS 127D PLANS YES $3^{0} \times 7^{0}$ CO CONFERENCE YES $3^{0} \times 7^{0}$

DOOR SCHEDULE

GENERAL NOTES:

 ALL NEW EXTERIOR DOORS TO COMPLY WITH FLORIDA PRODUCT APPROVAL. ALL NEW INTERIOR WOOD DOORS TO BE OF SOLID-CORE CONSTRUCTION, U.N.O.

YES

SPECIFIC NUMBERED NOTES FOR SCHEDULE:

ACCESS TO BE INSTALLED BY OWNER'S SUB.

CONFERENCE

LEAVE FRAMES, REMOVE DOORS AND STOPS. PATCH AND PAINT. DOOR TO BE CHANGED TO 3'-0" WIDE. RE-USE ELECTRICAL HARDWARE. USE OWNER'S

(2) $3^0 \times 7^0$ | 1 3/8 |

HM

STEEL

PAINT


FLUSH


STEEL

PAINT


|| Y | 3

3. OWNER-PROVIDED DOOR & FRAME. CONTRACTOR TO INSTALL. SECURITY CARD

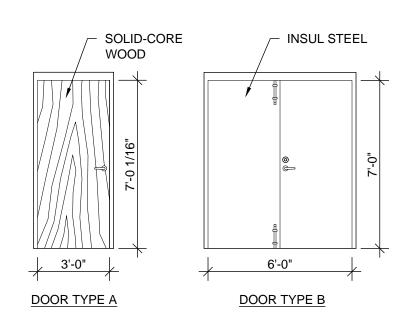


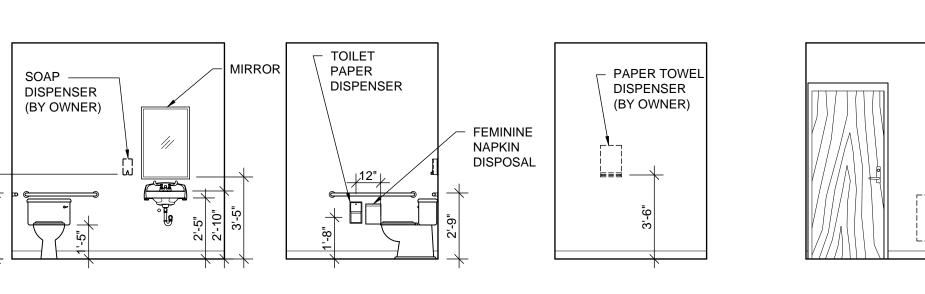


3 INT ELEV

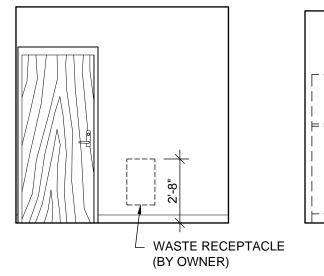

4 INT ELEV

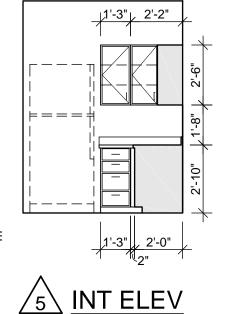

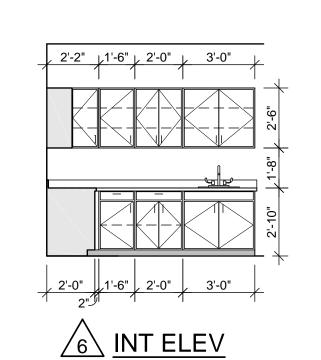

David Kramer Project Manager

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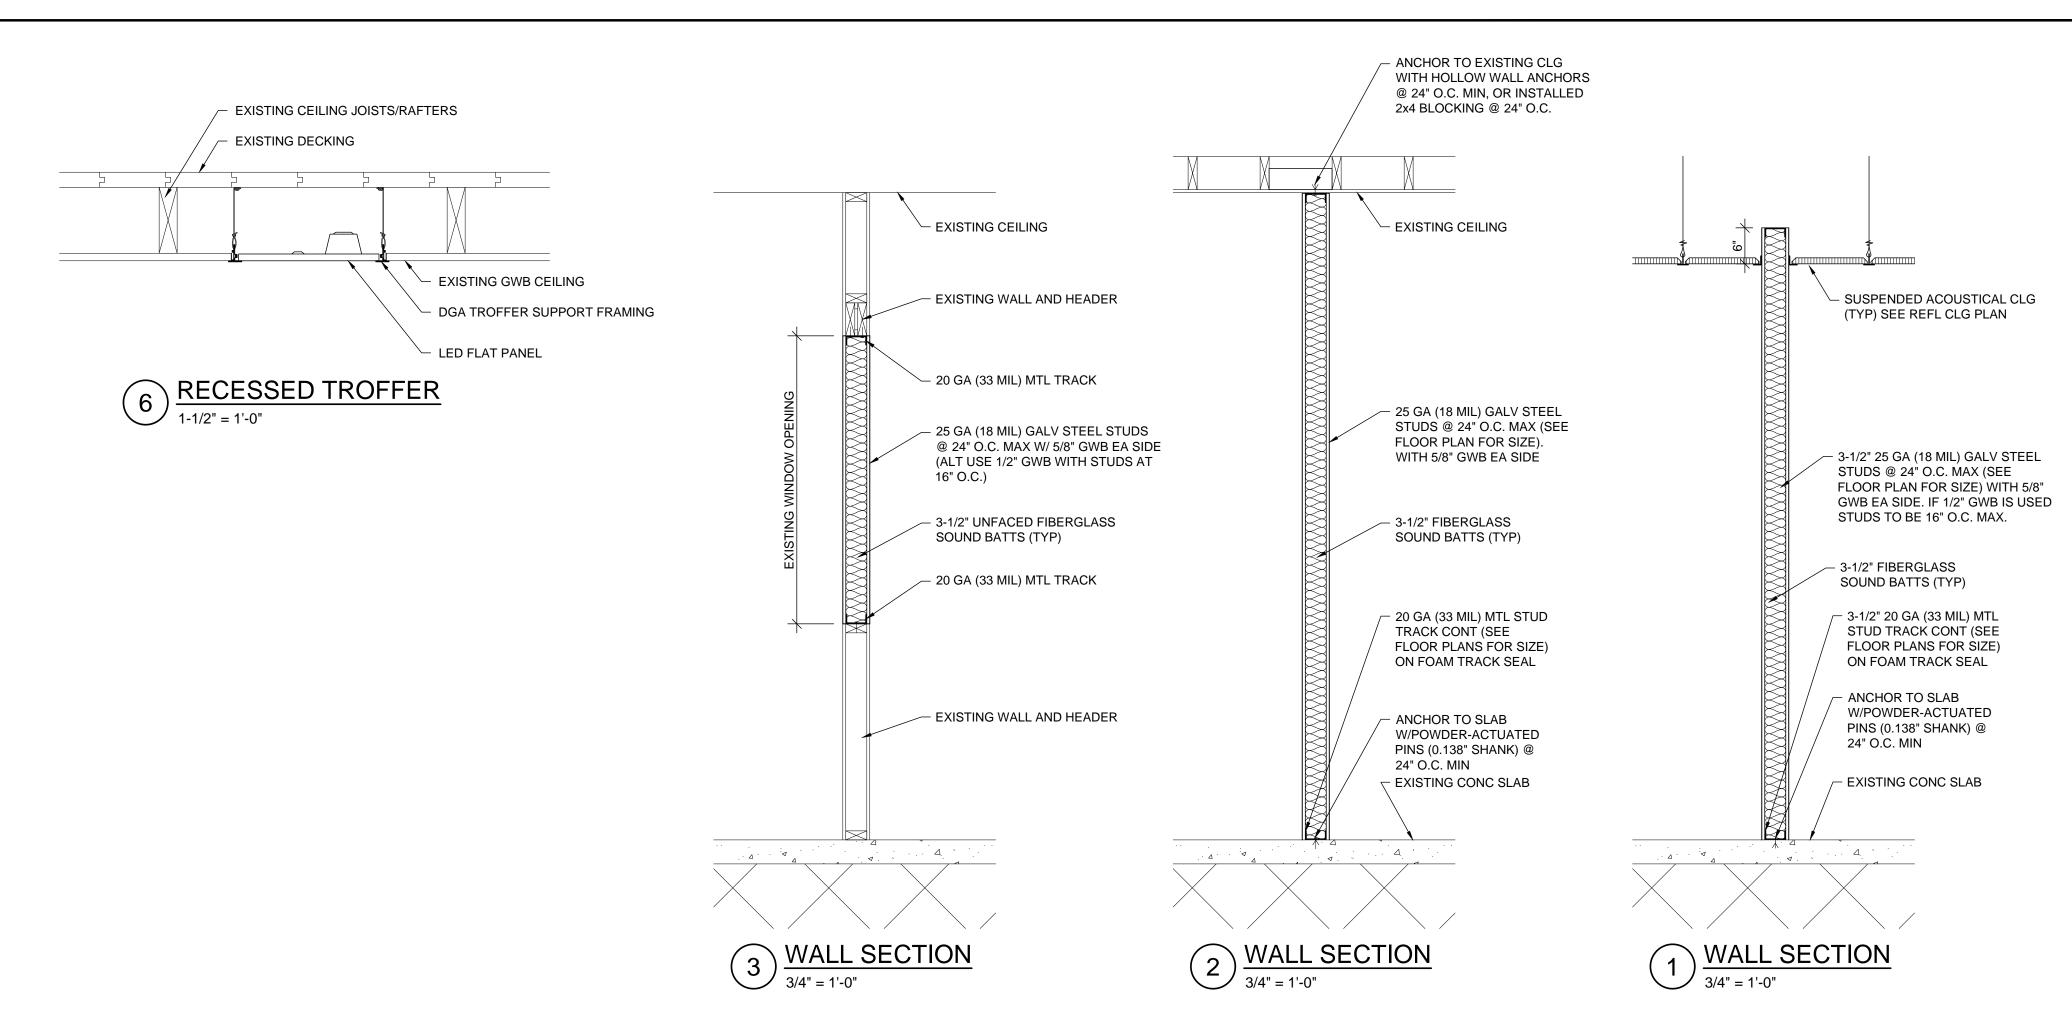
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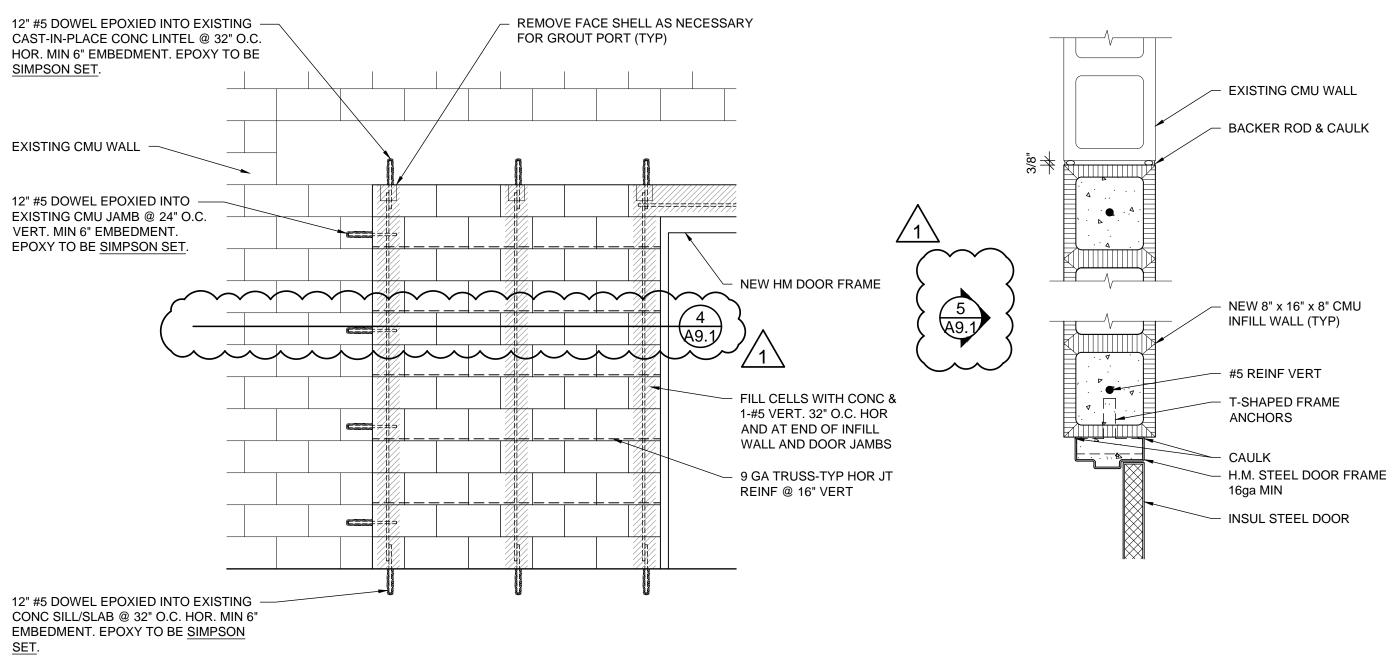
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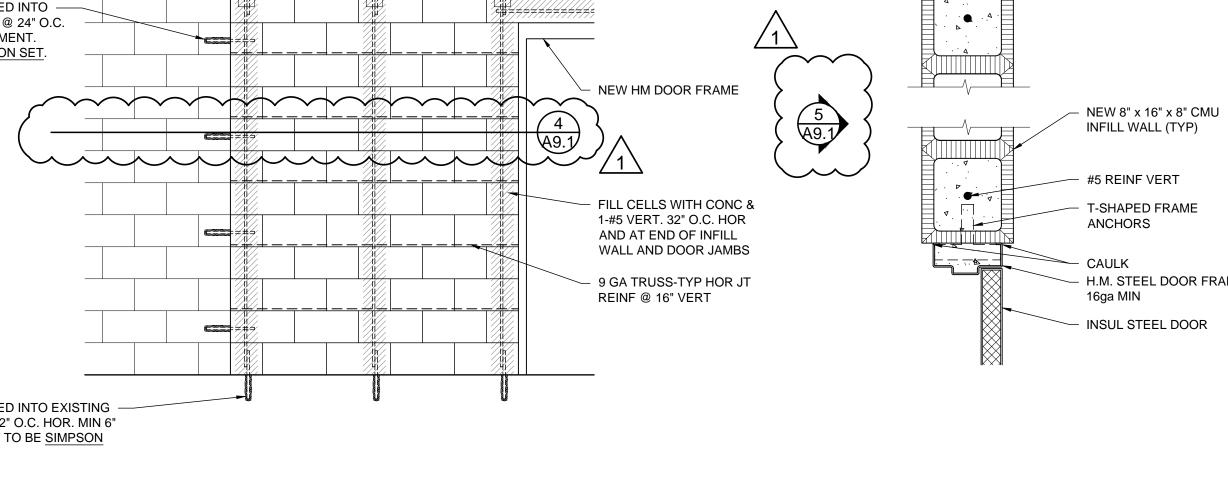
DIS.

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A7.1








 $5 \frac{\text{CMU INFILL WALL ELEVATION}}{\frac{1}{2"} = \frac{1}{0}}$

 $\frac{\text{CMU WALL INFILL}}{1-1/2" = 1'-0"}$

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7 PARTIAL SECOND FLOOR PLAN
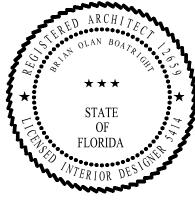
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REMOVE EXISTING -

HANDRAIL/WALL

CONNECT EXISTING -

LIGHT TO 2ND FLOOR

SWITCH CIRCUIT

ABANDON —

CONDUCTORS TO

1ST FLR SWITCH

EXISTING LIGHT

- EXISTING LIGHT CIRCUIT, SWITCH AND LIGHT

2x6 JOISTS @ 12" O.C. TO SPAN

STAIRWELL AND PROVIDE A

STORAGE. COVER WITH 3/4"

SHEATHING. SAVE SOME OF

2x6 LEDGER, DLB-NAILED

TO EXISTING EXT STUDS. USE SIMPSON LU26 JOIST HANGERS.

2x6 BLOCKING BETW

EDGE NAILING (TYP)

JOISTS FOR SHEATHING

REMOVE ALL EXISTING


HANDRAILS

THE DEMOLISHED CARPET TO

FLOOR FOR 2ND FLR

T&G PLYWD FLOOR

COVER PLYWD.

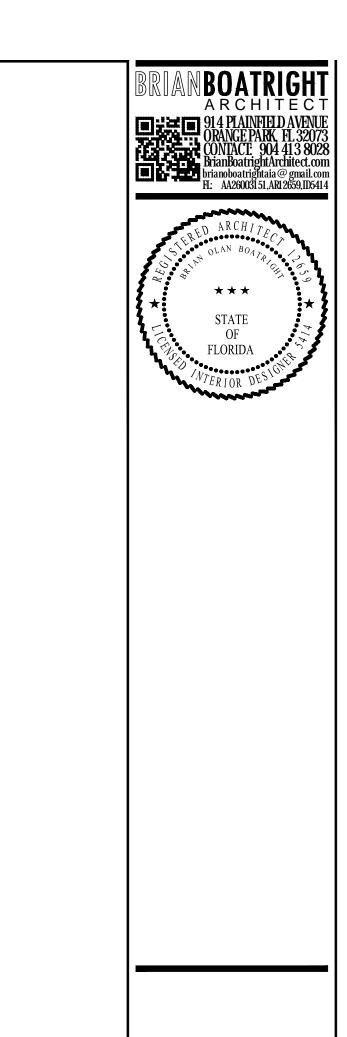



COVE

GREEN

CENTER

REVISIONS NO DATE COMMENT


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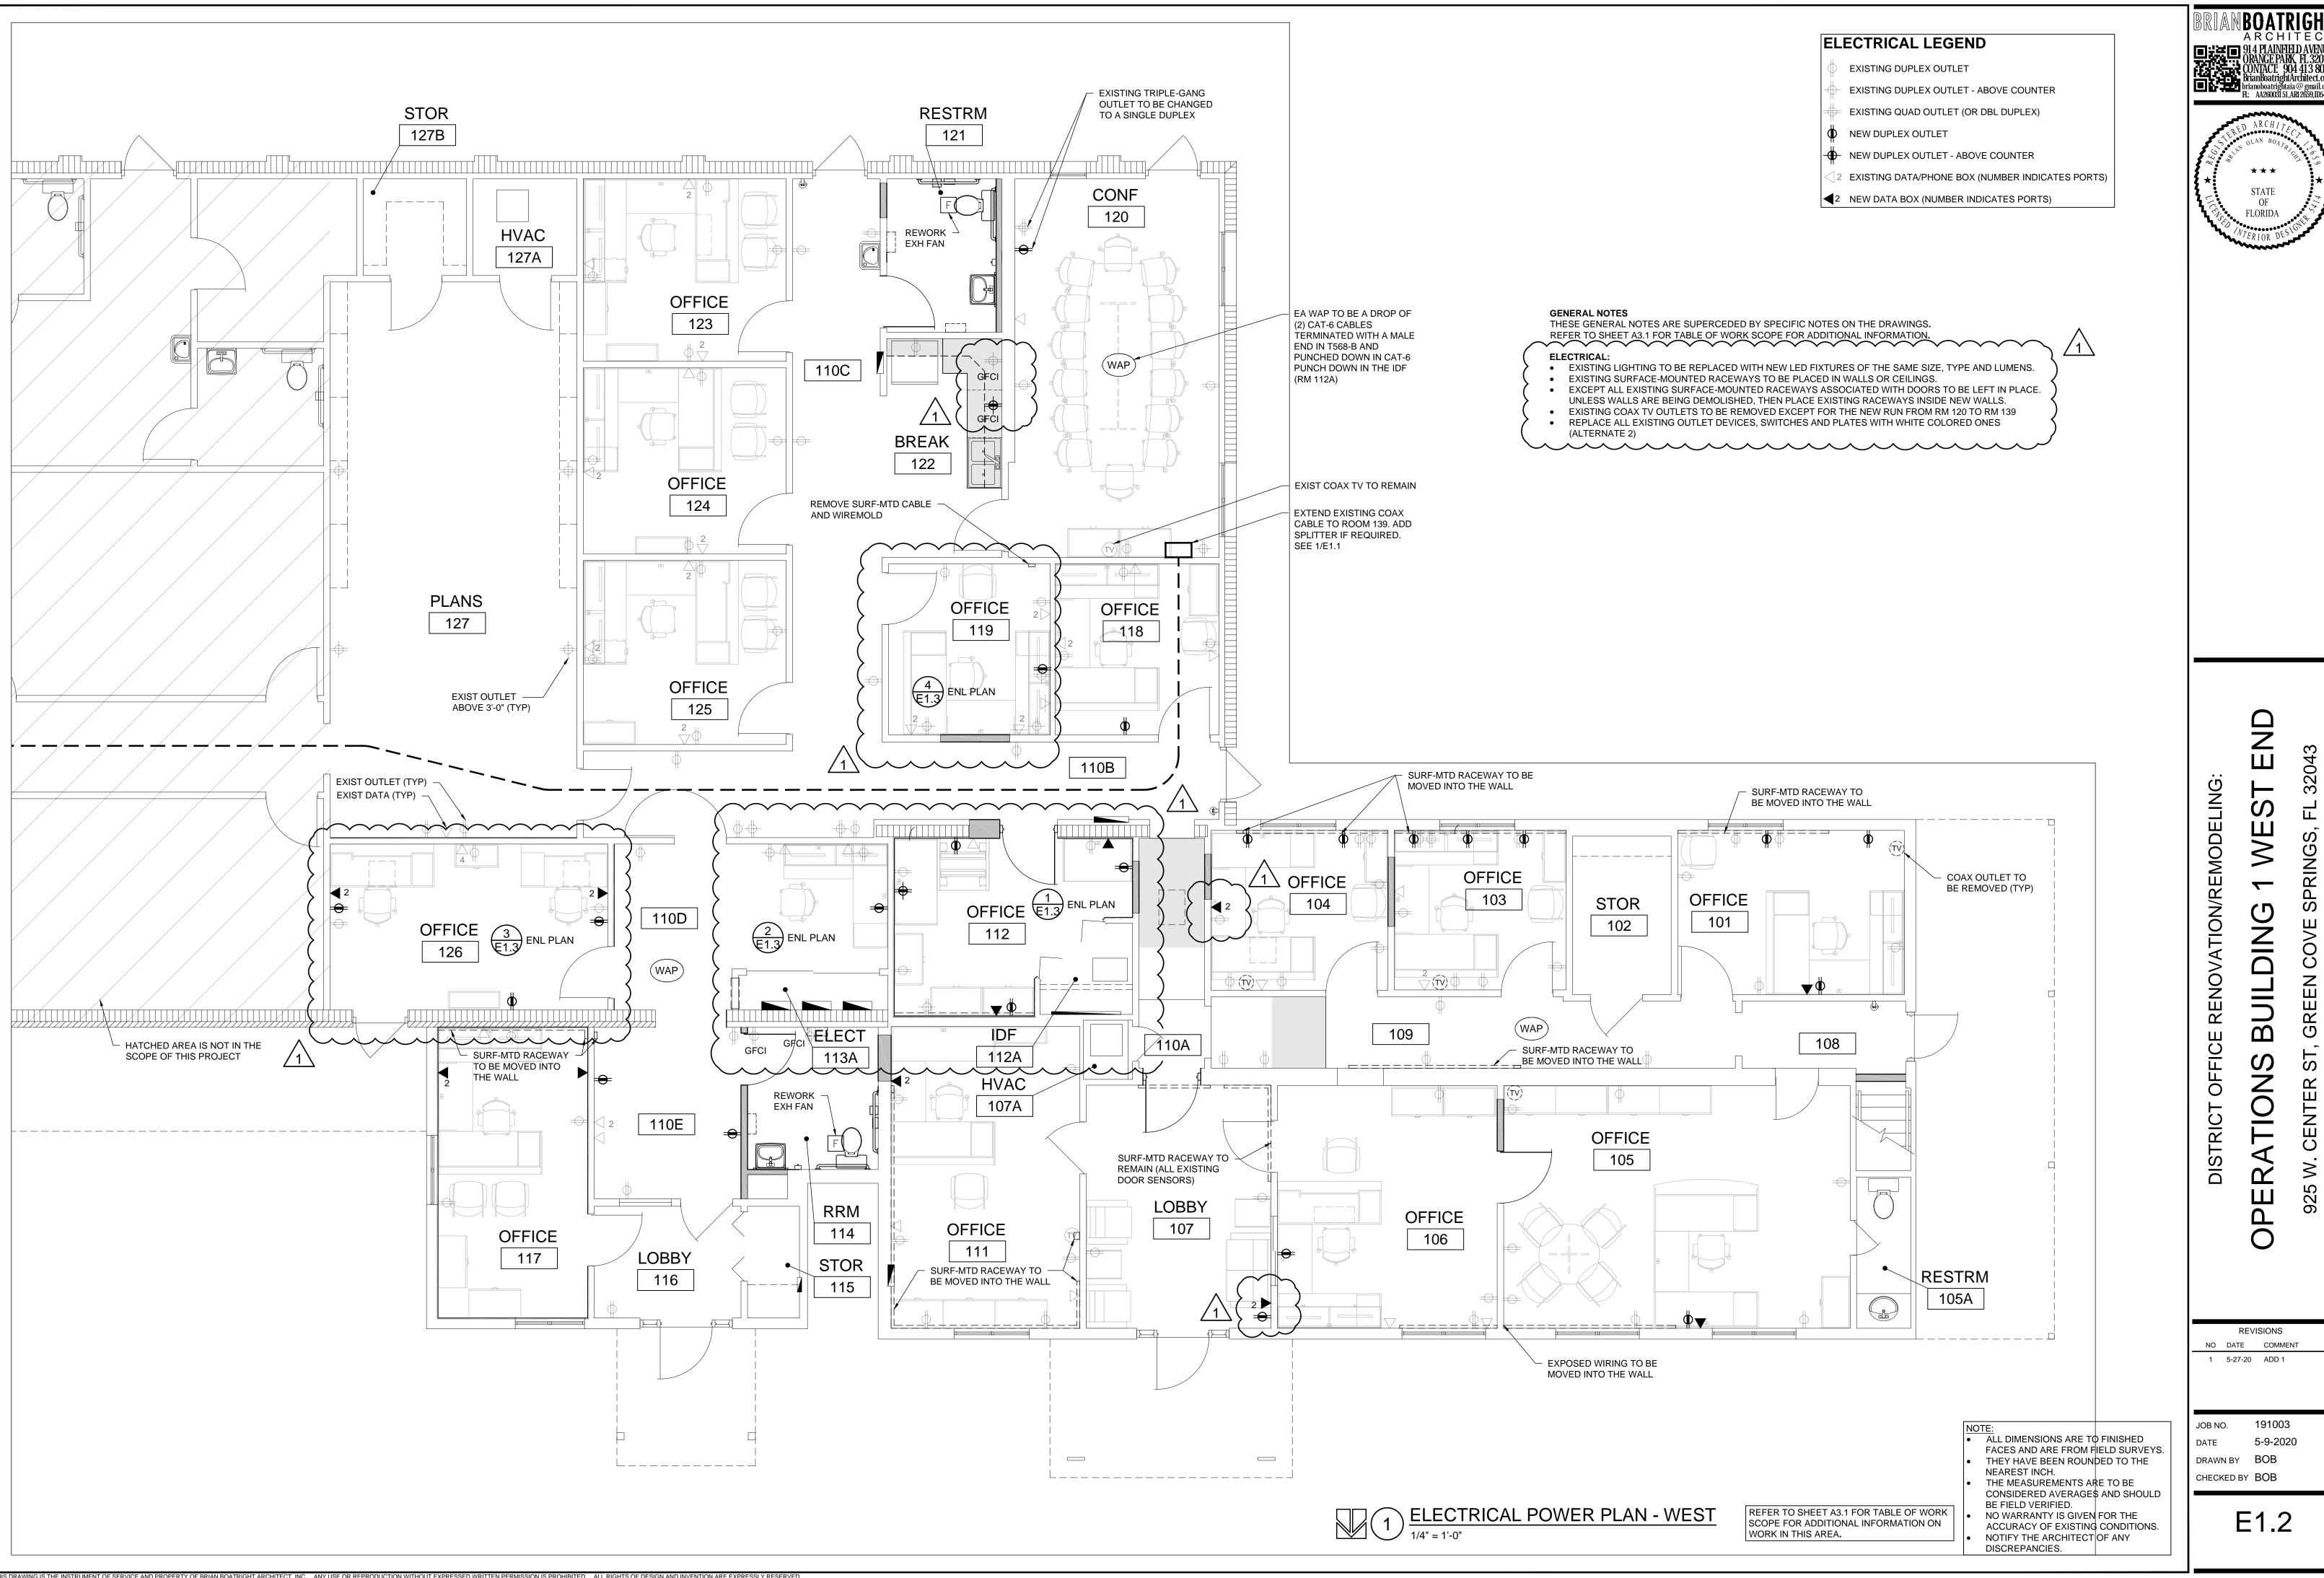
DATE 5-9-2020

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CHECKED BY BOB

E1.1




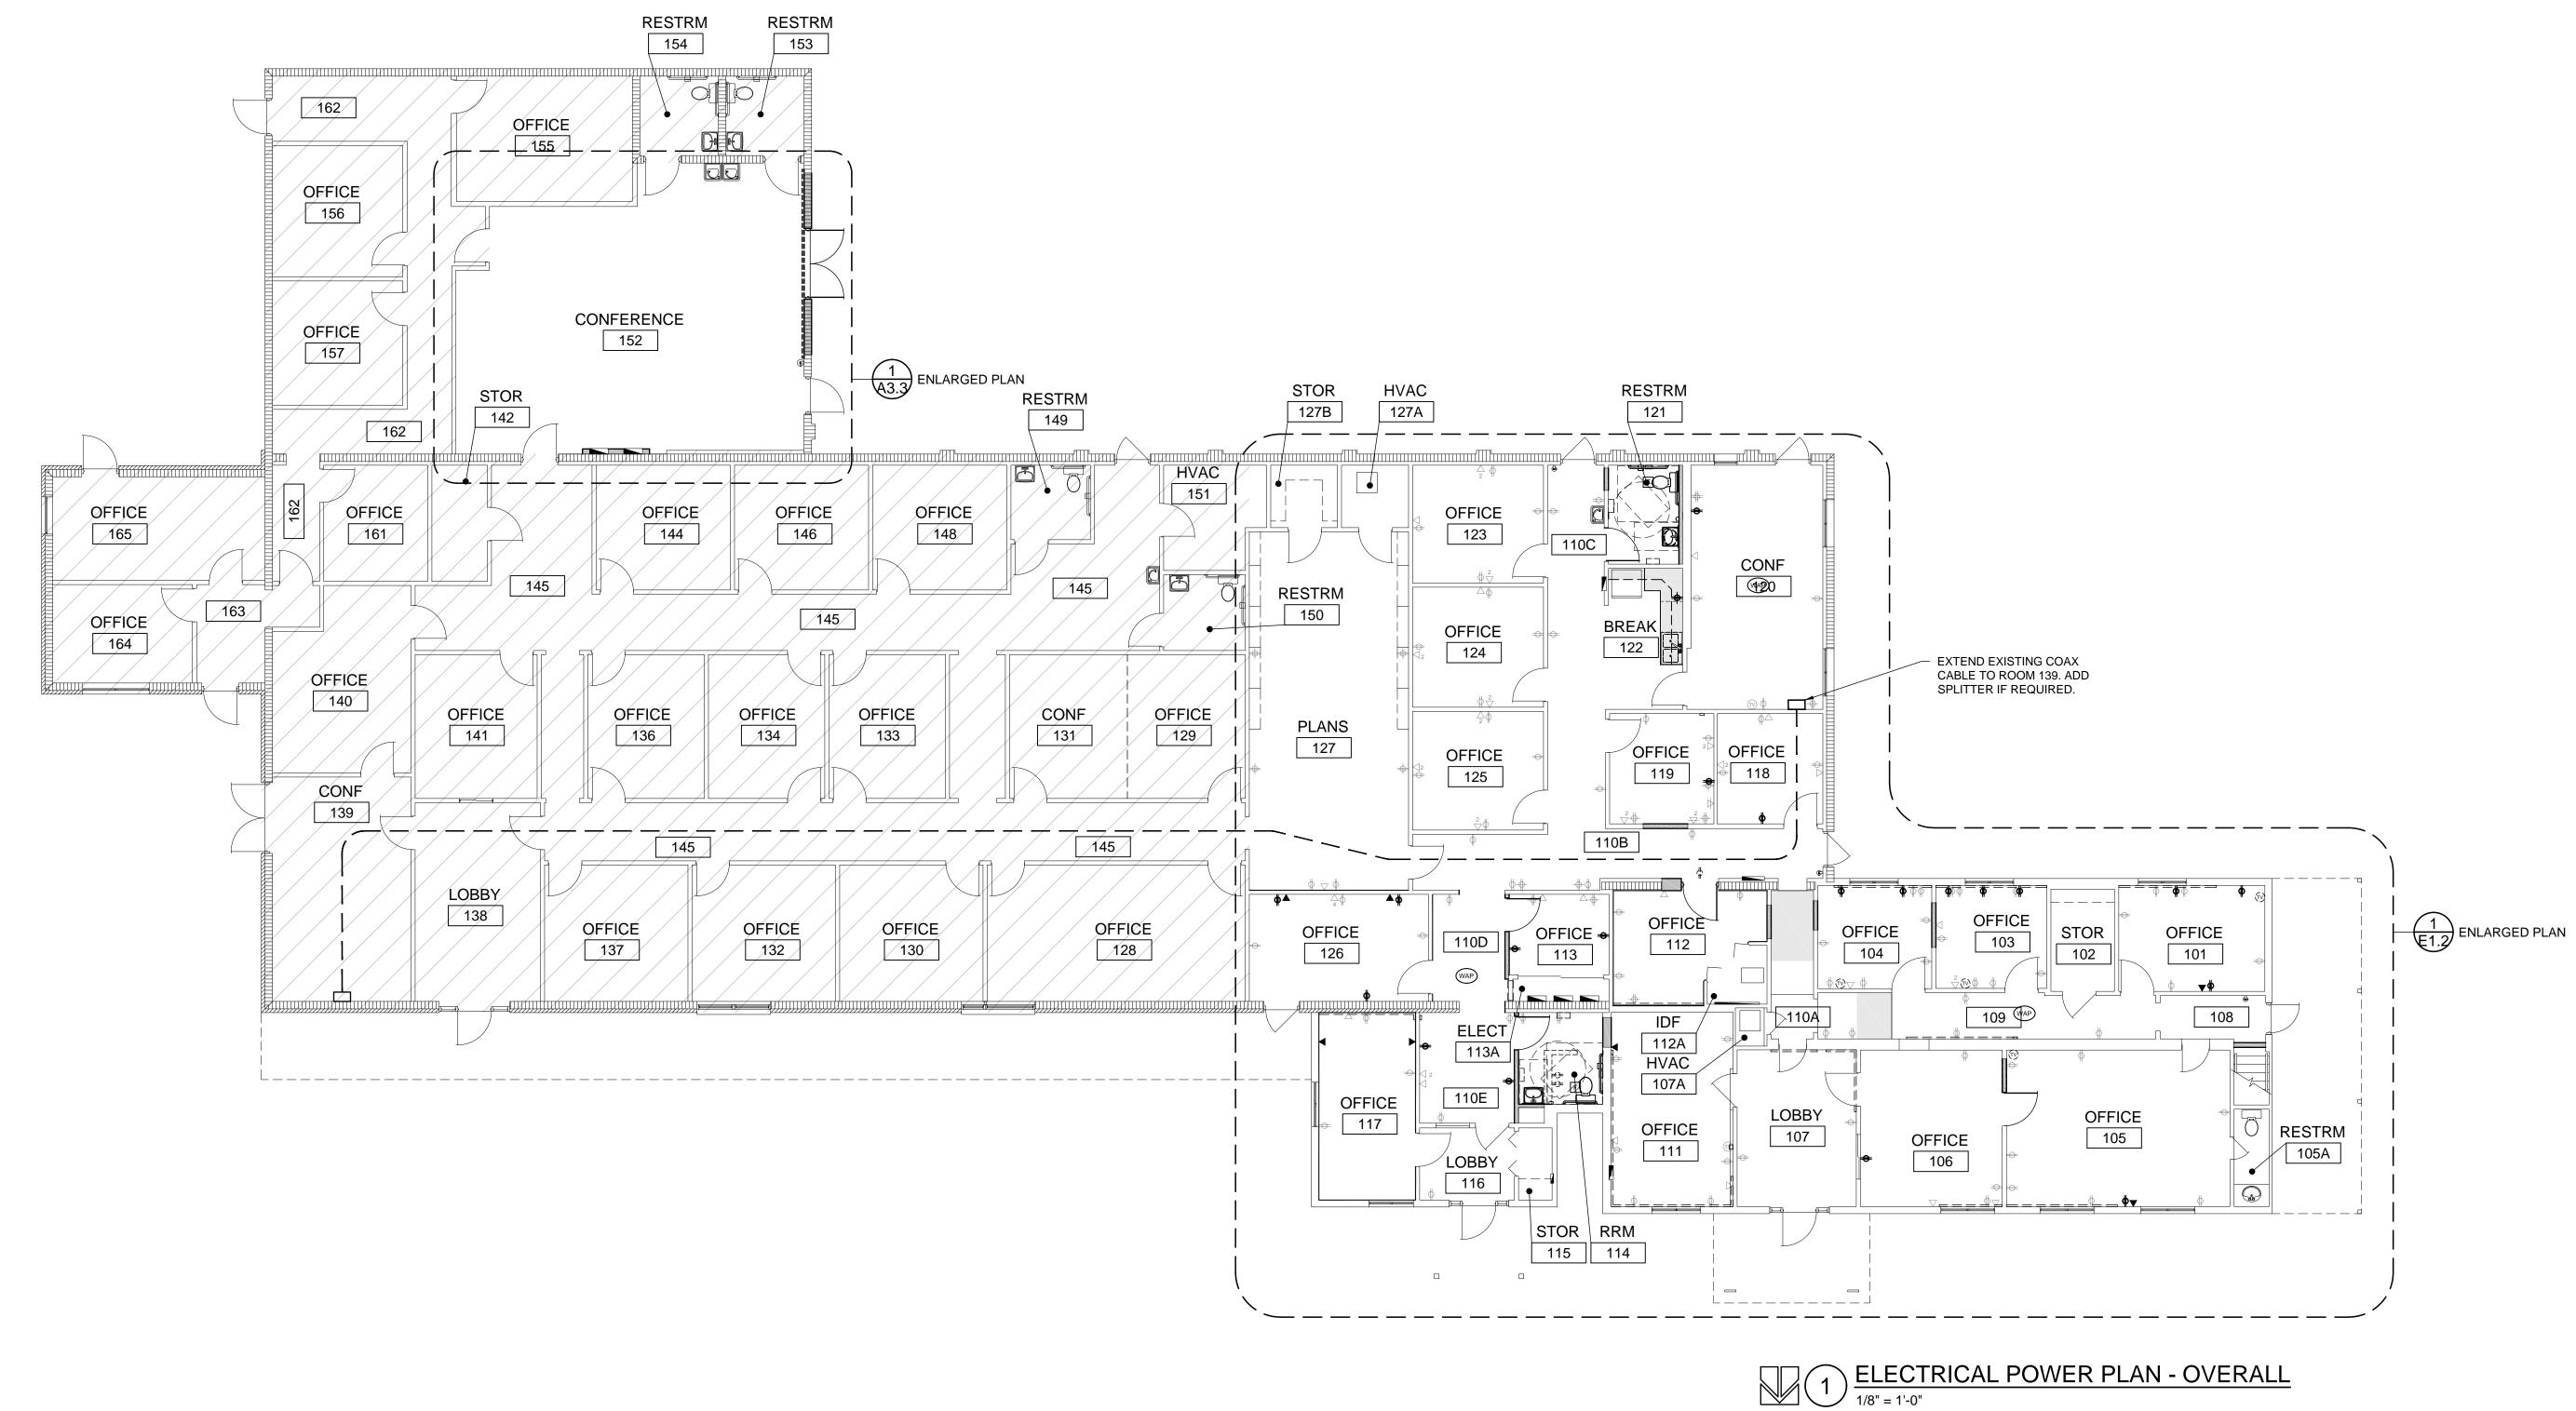

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5-9-2020



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CONSIDERED AVERAGES AND SHOULD

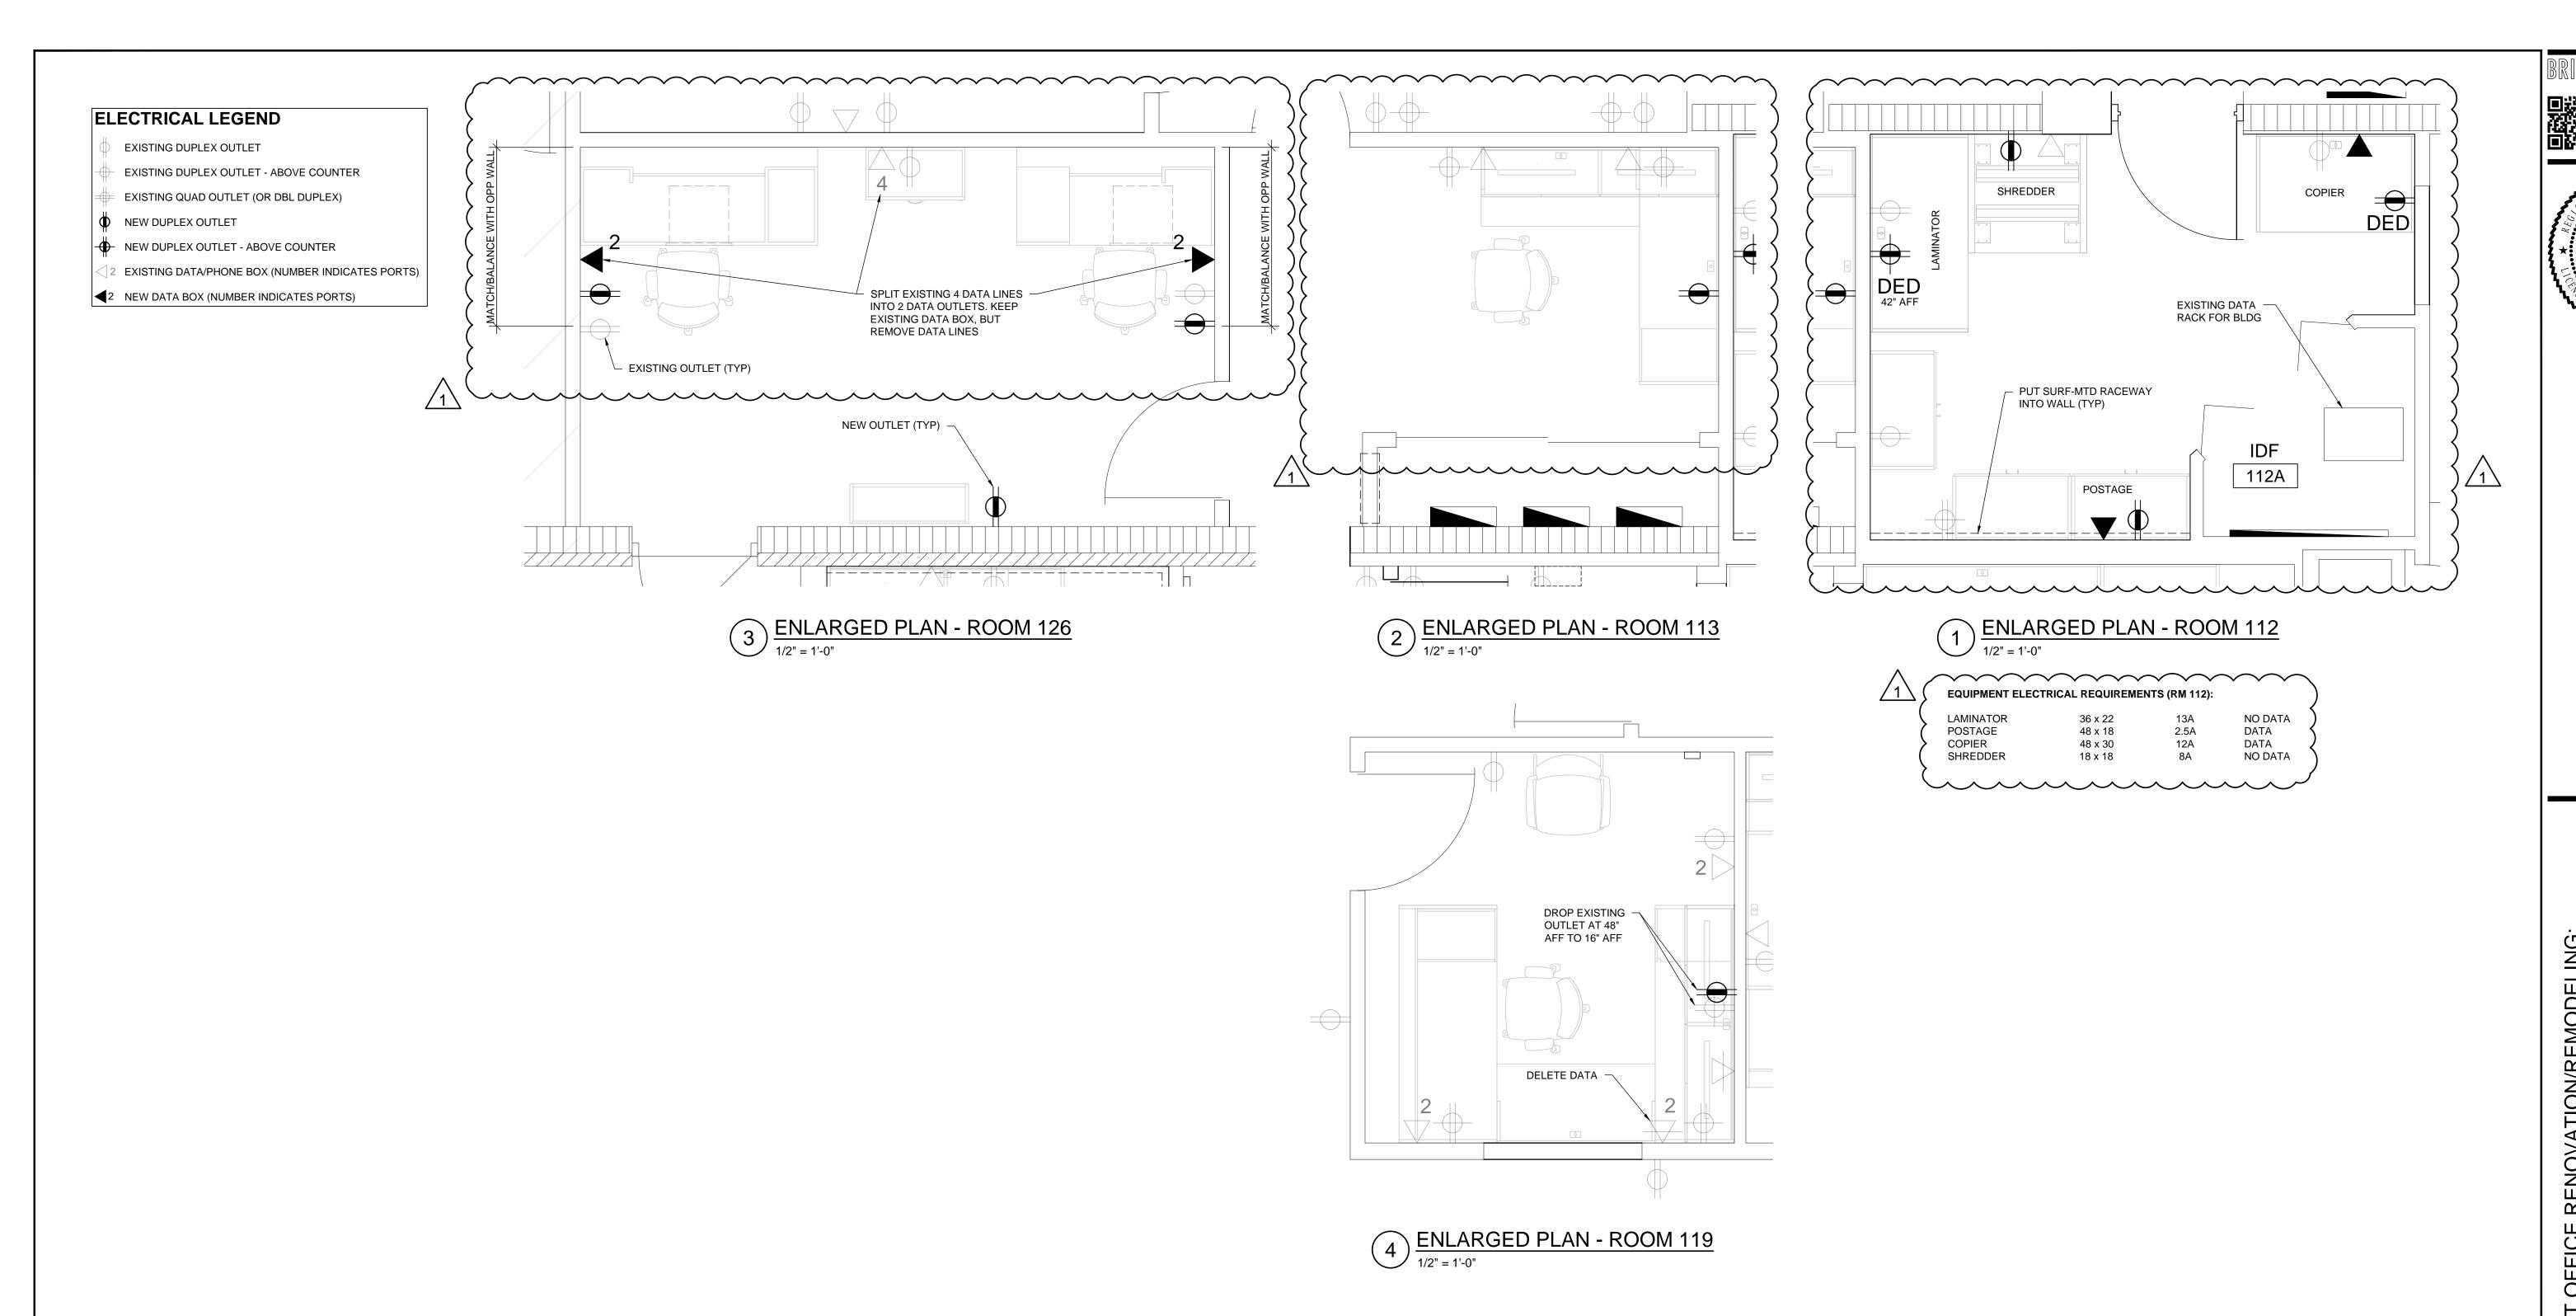NEAREST INCH.