PROJECT DESCRIPTION

TENANT BUILD-OUT WITHIN AN EXISTING BUILDING.

JURISDICTION- ORANGE PARK, FLORIDA

APPLICABLE BUILDING CODES

2017 FLORIDA BUILDING CODE 2017 FLORIDA MECHANICAL CODE 2017 FLORIDA PLUMBIMG CODE

SIXTH EDITION FLORIDA FIRE PREVENTION CODE 2014 NATIONAL ELECTRICAL CODE

FLORIDA BUILDING CODE, EXISTING BUILDING PROPOSED CONSTRUCTION IS A LEVEL 3 ALTERATION AND WILL COMPLY WITH CHAPTERS 6,

PROPOSED CONSTRUCTION DOES NOT INVOLVE A CHANGE OF OCCUPANCY.

FLORIDA BUILDING CODE, BUILDING

OCCUPANCY: GROUP B, BUSINESS MEDICAL OFFICES

AREA OF EXISTING BUILDING TO BE RENOVATED = 3,304 SQ. FT. AREA OF PROPOSED CONSTRUCTION: FIRST FLOOR = 3,304 SQ. FT.

NUMBER OF STORIES = 1

CONSTRUCTION TYPE III(B), UNPROTECTED, UNSPRINKLERED.

CHAPTER 10 - OCCUPANT LOAD AND EGRESS

BUSINESS (100 GROSS) 3,304 SF / 100 = 34 EGRESS WIDTH, FIRST FLOOR: 34 X 0.20 = 6.8" REQUIRED. 72" PROVIDED.

CORRIDOR WALLS ARE NOT REQUIRED TO BE RATED PER EXEPTION NO. 4. GROUP B OCCUPANT LOAD IS LESS THAN THE MAXIMUM ALLOWABLE FOR A

SINGLE EXIT PER TABLE 1006.2.1 TWO EXITS ARE PROVIDED. INTERIOR FINISHES: UNSPRINKLERED BUILDING
EXITS AND EXIT PASSAGEWAYS: CLASS A CORRIDORS: CLASS B ROOMS AND ENCLOSED AREAS: CLASS C

CHAPTER 12 - INTERIOR ENVIRONMENT

SECTION 1210.2.2 - FOR RESTROOMS ACCESSIBLE TO THE PUBLIC WALLS AND PARTITIONS WITHIN 2'-0" OF SERVICE SINKS, URINALS AND WATER CLOSETS SHALL HAVE A SMOOTH, HARD, NON-ABSORBANT SURFACE TO A MINIMUM HEIGHT OF 4'-0" A.F.F.

PLUMBING REQUIREMENTS PER CHAPTER 4, FBC, PLUMBING

BUSINESS OCCUPANCY

WATER CLOSETS: 1 PER 25 OCCUP. 2 REQUIRED, 3 PROVIDED LAVATORIES: 1 PER 40 OCCUP. 2 REQUIRED, 3 PROVIDED.

TACTILE SIGNAGE REQUIREMENTS:

PROVIDE HANDICAPPED ACCESSIBLE IDENTIFICATION/TACTILE SIGNAGE AT ALL DOORS WITH EXIT SIGNS AND RESTROOMS IN COMPLIANCE WITH FBC 11-4.12 (7), FBC 11-4.30.4 & NFPA 101-7.10.13. SIGNAGE AT EXIT DOORS SHALL BE MOUNTED 60" AFF ON THE LATCH SIDE. SIGNAGE AT STOREFRONT DOORS AND FRAMING SHALL NOT EXCEED THE WIDTH OF THE DOOR STILE OR FRAMING MEMBER.

PROPOSED CONSTRUCTION DOES NOT INVOLVE LIGHT GAUGE TRUSS-TYPE CONSTRUCTION AND IS NOT SUBJECT TO THE REQUIREMENTS OF FAC 69A-60.0081

PROVIDE LIGHT GAUGE TRUSS-TYPE CONSTRUCTION SIGNAGE PER FAC 69A-60.0081 PER EXAMPLE BELOW

FLORIDA FIRE PREVENTION CODE SUMMARY

(6TH EDITION, FLORIDA FIRE PREVENTION CODE)

CONSTRUCTION TYPE: III-B, PER FLORIDA BUILDING CODE UNPROTECTED, UN-SPRINKLERED.

SECTION 6.2 - CLASSIFICATION OF HAZARD OF CONTENTS ORDINARY HAZARD PER SECTION 6.2.2.3

CHAPTER 38 - NEW BUSINESS OCCUPANCY

MEDICAL OFFICES GROSS AREA:

FIRST FLOOR: 3,304 SQ. FT. AREA TO BE RENOVATED - 3,304 SQ. FT.

NUMBER OF STORIES: 1

INTERIOR WALL AND CEILING FINISHES SHALL BE CLASS A OR CLASS B INTERIOR FLOOR FINISHES IN EXIT ENCLOSURES SHALL BE NOT LESS THAN CLASS II

OCCUPANT LOAD PER TABLE 7.3.1.2:

BUSINESS (100 GROSS) 3,304 SF / 100 = 34 EGRESS WIDTH PER TABLE 7.3.3.1:

EGRESS WIDTH, FIRST FLOOR: 34 X 0.20 = 6.8" REQUIRED. 72" PROVIDED.


BUSINESS OCCUPANCY - UNSPRINKLERED ALLOWABLE DEAD END LIMIT = 20 FT. ALLOWABLE COMMON PATH LIMIT = 75 FT. (TABLE A.7.6) ALLOWABLE TRAVEL DISTANCE LIMIT = 200 FT. (TABLE A.7.6)

FIRE ALARM SYSTEM IS NOT PROPOSED.


PORTABLE FIRE EXTINGUISHER (LS 9.7.4): PER NFPA 10 "STANDARD FOR PORTABLE FIRE EXTINGUISHERS". SEE PLAN FOR LOCATIONS

FIRE-STOP SYSTEMS THROUGH-PENETRATION FIRE-STOP SYSTEMS SHALL CONFORM TO THE FOLLOWING: METALLIC PIPE, CONDUIT OR TUBING UL SYSTEM W-L-1054 NON-METALLIC PIPE, CONDUIT OR TUBING UL SYSTEM W-L-2098 TELEPHONE AND ELECTRICAL CABLES UL SYSTEM W-L-3065 UL SYSTEM W-L-5021 INSULATED METALLIC PIPE MISC. ELECTRICAL PENETRATIONS UL SYSTEM W-L-3065 MISC. MECHANICAL PENETRATIONS UL SYSTEM W-L-7003

ARCHITECT'S STATEMENT: TO THE BEST OF MY KNOWLEDGE, THIS DESIGN COMPLIES WITH THE REQUIREMENTS OF THE SIXTH EDITION OF THE FLORIDA FIRE PREVENTION CODE. (FFPC)

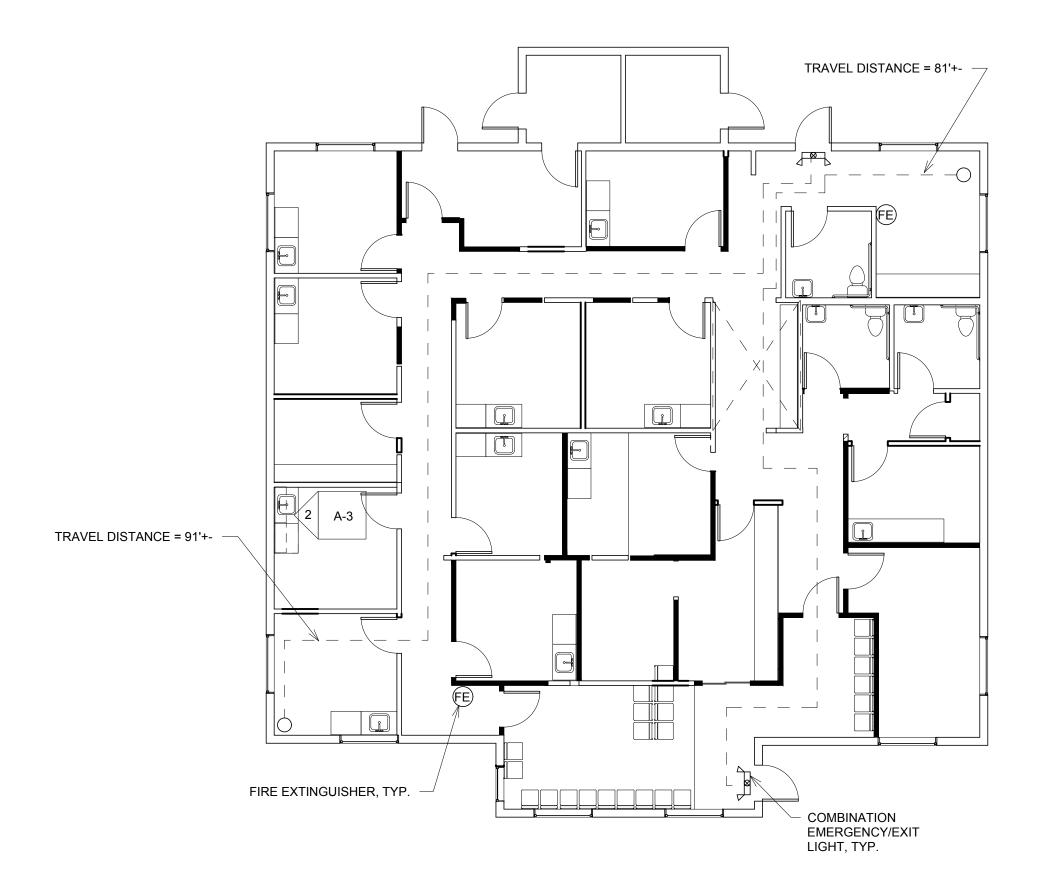

1 LIFE SAFETY PLAN 1/8" = 1'-0"

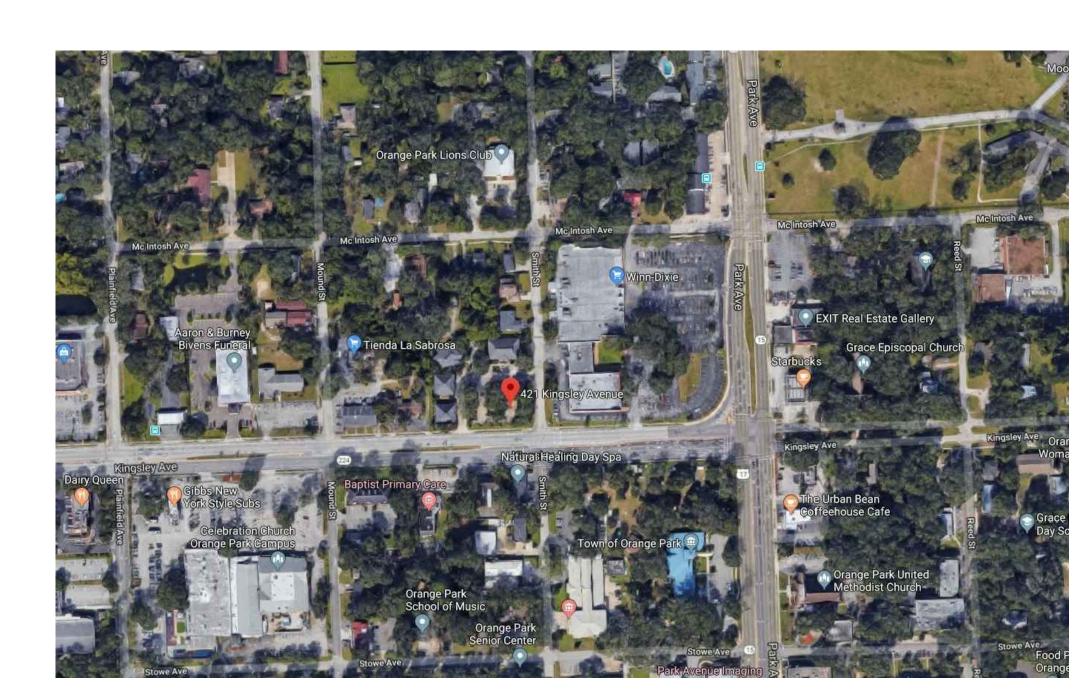

LOCATION MAP

OPMENT orporated

REVISIONS

D. SCOTT FRASER


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4/8/2019 11:37:26 AM JOB NUMBER

SCALE 1/8" = 1'-0"

Project Number

DRAWING NUMBER **C-1**

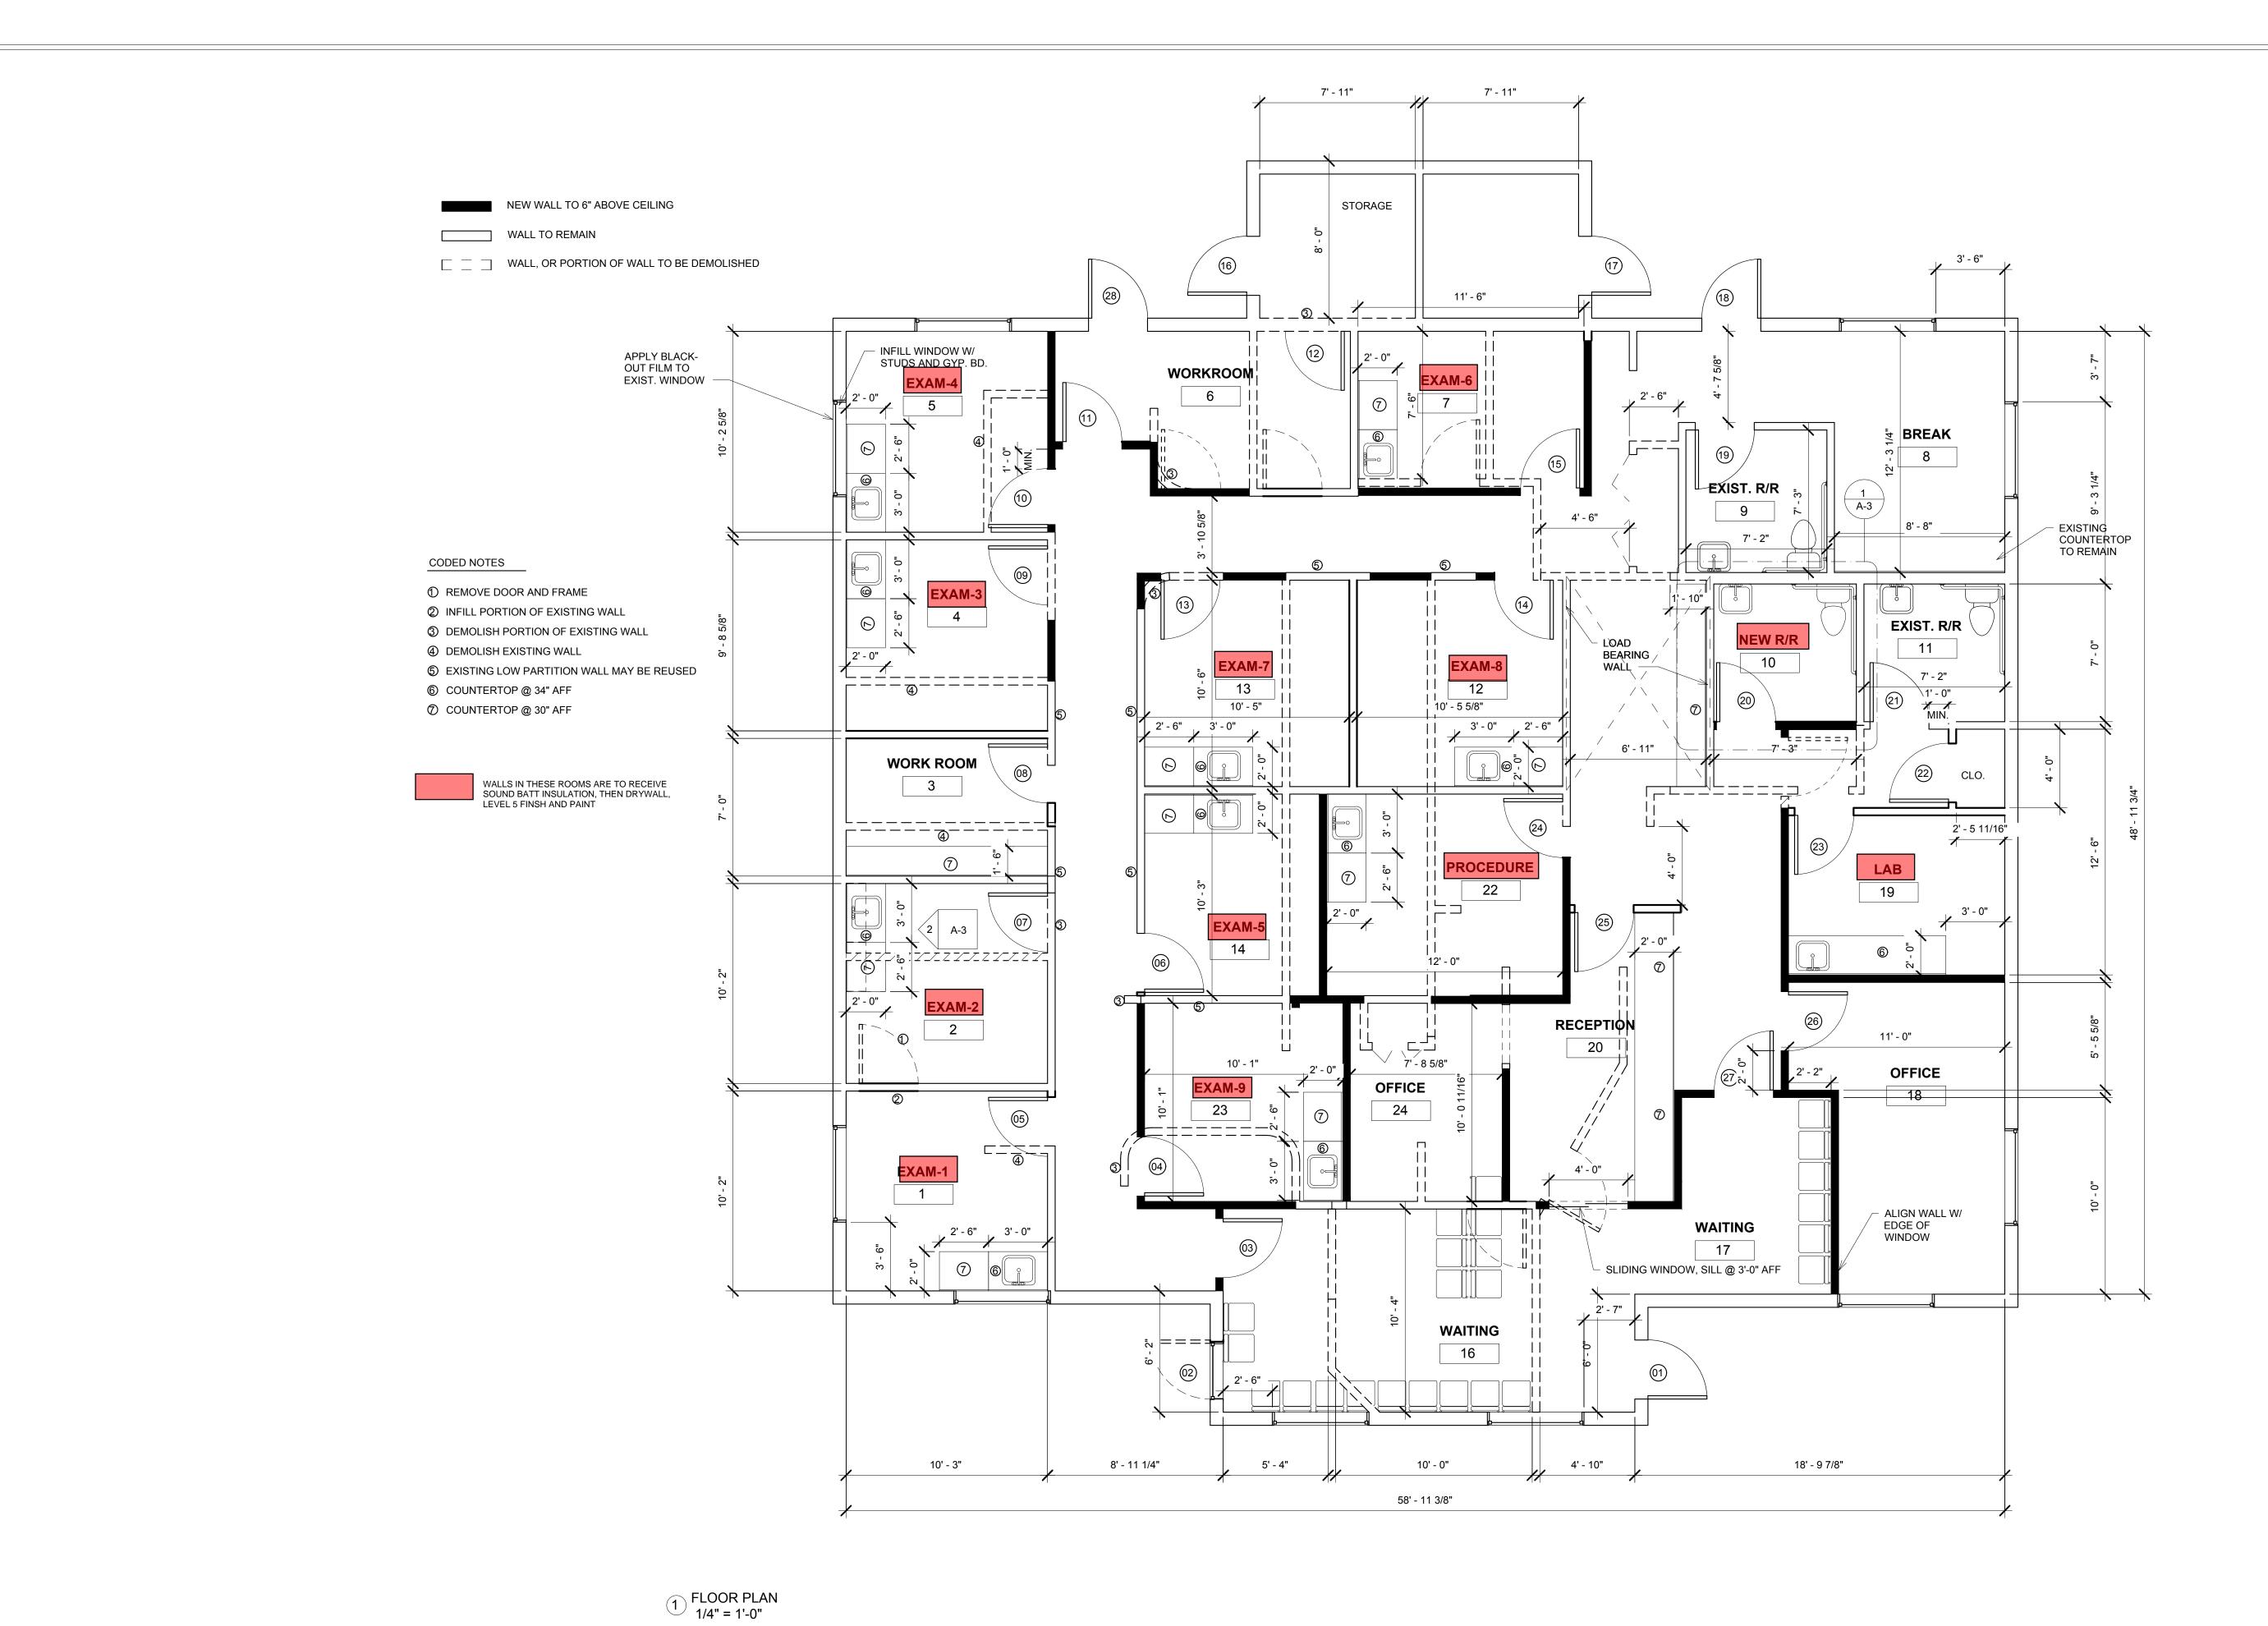

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COASTAL MEDICAL
421 KINGSLEY AVENUE
ORANGE PARK, FL
FLOOR PLAN

REVISIONS

D. SCOTT FRASER

AR-0013099

<u>DATE</u> 4/8/2019 11:37:19 AM

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JOB NUMBER


Project Number

SCALE

1/4" = 1'-0"

DRAWING NUMBER

A-1

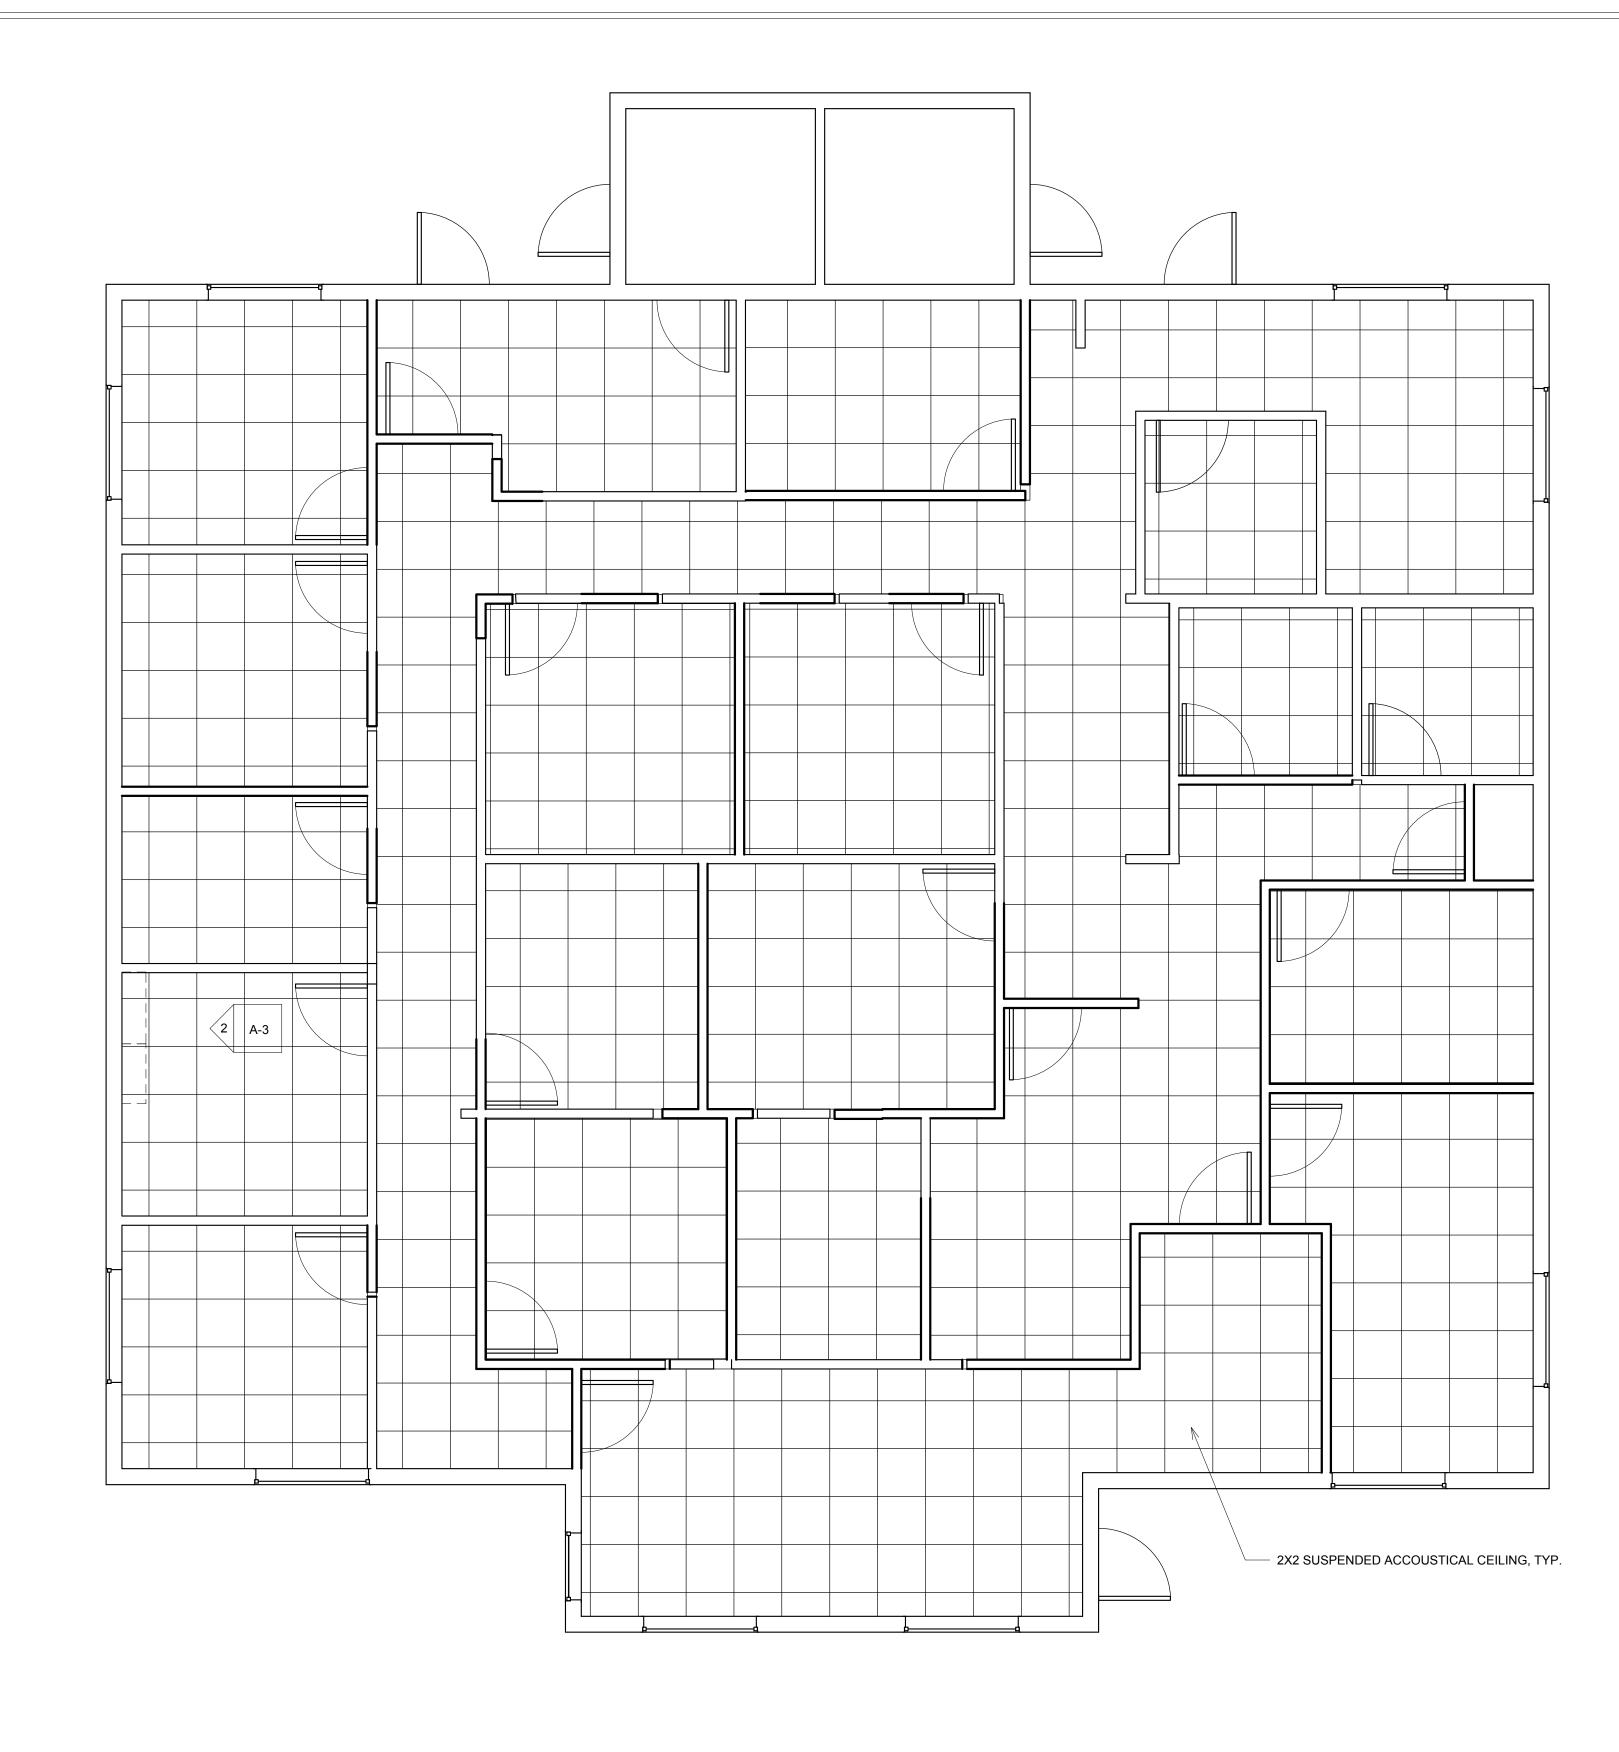

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COASTAL MEDICAL
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ORANGE PARK, FL
CEILING PLAN

REVISIONS

D. SCOTT FRASER


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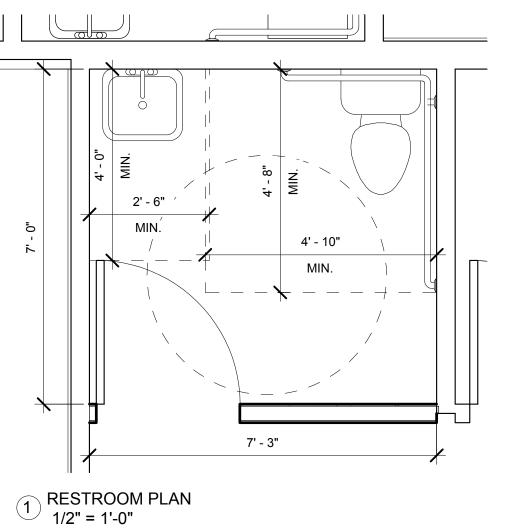
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Project Number


<u>SCALE</u> 1/4" = 1'-0"


DRAWING NUMBER

A-2



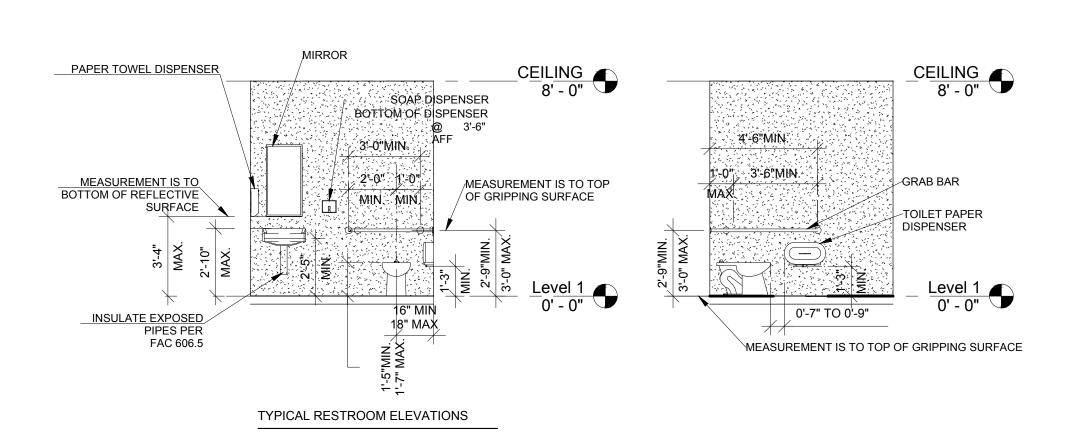

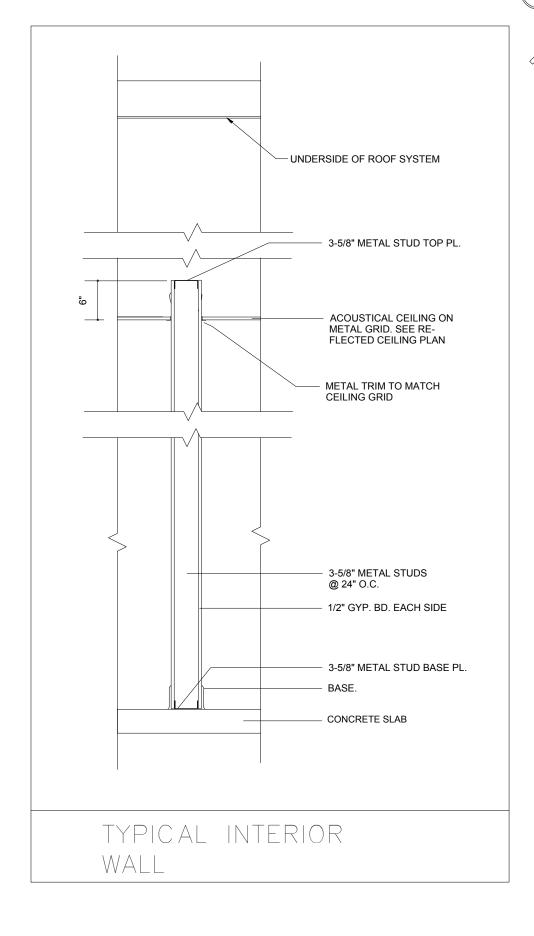

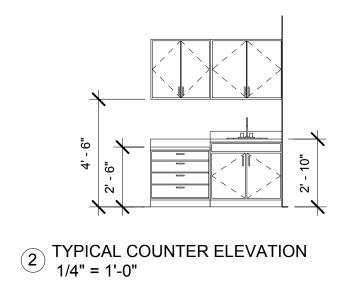

)	SC	HEDUL	
000R	SIZE	MATERIAL	GLASS	JAMB	HARDWARE	REMARKS
01	36" WIDE				DEADBOLT	EXIST. DOOR TO REMAIN
02	36" WIDE				DEADBOLT	SECURE EXIST. DOOR
03	3070	S.C. WOOD	VIEW	H.M.	PASSAGE	
04	3070	S.C. WOOD	NONE	H.M.	PASSAGE	
05	3070	S.C. WOOD	NONE	H.M.	PASSAGE	
06	3070	S.C. WOOD	NONE	H.M.	PASSAGE	
07	3070	[S.C. WOOD]	NONE	H.M.	PASSAGE	
08	3070	S.C. WOOD	NONE	H.M.	PASSAGE	
09	3070	S.C. WOOD	NONE	H.M.	PASSAGE	
10	3070	S.C. WOOD	NONE	H.M.	PASSAGE	
11	3070	S.C. WOOD	NONE	H.M.	PASSAGE	
12	3070	S.C. WOOD	NONE	H.M.	PASSAGE	
13	3070	S.C. WOOD	NONE	H.M.	PASSAGE	
14	3070	S.C. WOOD	NONE	H.M.	PASSAGE	
15	3070	S.C. WOOD	NONE	H.M.	PASSAGE	
16	36" WIDE					EXIST. DOOR TO REMAIN
17	36" WIDE					EXIST. DOOR TO REMAIN
18	36" WIDE					EXIST. DOOR TO REMAIN
19	36" WIDE	S.C. WOOD	NONE		PRIVACY	EXIST. DOOR TO REMAIN
20	3070	S.C. WOOD	NONE	H.M.	PRIVACY	
21	36" WIDE	S.C. WOOD	NONE	H.M.	PRIVACY	
22	3070	S.C. WOOD	NONE	H.M.	PASSAGE	
23	3070	S.C. WOOD	NONE	H.M.	PASSAGE	
24	3070	S.C. WOOD	NONE	H.M.	PASSAGE	
25	3070	S.C. WOOD	NONE	H.M.	PASSAGE	
26	3070	S.C. WOOD	NONE	H.M.	PASSAGE	
27	3070	S.C. WOOD	VIEW	H.M.	PASSAGE	
28	36" WIDE					SECURE EXIST. DOOR

DOOR CLOSERS SHALL BE PROVIDED IN COMPLIANCE WITH SECTION 404.2.9 AND SECTION 309 FBC ACCESSIBILITY. ALL DOOR HARDWARE SHALL BE LEVER—ACTIVATED.

STOREFRONT DOOR W/ THUMB OPERATED LOCKING DEVICE TO COMPLY W/ FBC SECTION 1008.1.9.3. POST SIGN ON OR ADJACENT TO DOOR W/

MIN. 1" LETTERS: "THIS DOOR TO REMAIN UNLOCKED WHEN BUILDING IS OCCUPIED"

PANIC HARDWARE SHALL COMPLY WITH SECTION 7.2.1.7 FLORIDA FIRE PREVENTION CODE.

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AR-0013099

4/8/2019 11:37:24 AM JOB NUMBER Project Number

SCALE
As indicated
DRAWING NUMBER

A-3

FIXTUR	E DESCRIPTION	MANUFACTURER	WASTE	CW	HW
WC-1	WATER CLOSET, ADA CADET, RIGHT HEIGHT, ELONGATED TOILET. VITREOUS CHINA, FLOOR MOUNTED, FLOOR OUTLET, FLUSH TANK TYPE, LOW CONSUMPTION 1.6 GPF. SEAT INSTALLED 18" HIGH FROM FINISH FLOOR TO TOP OF SEAT.	AMERICAN STANDARD #2998.012	3"	1/2"	_
	SEAT: EXTRA HEAVY DUTY PLASTIC, OPEN FRONT SEAT LESS COVER WITH CONCEALED CHECK AND STAINLESS STEEL HINGE POST.	BEMIS CHURCH OLSONITE			
	STOPS/ACCESSORIES: 1/2" CHROME PLATED BRASS WHEEL HANDLE ANGLED STOP, CHROME PLATED STEEL FLANGE AND 12" FLEXIBLE CHROME PLATED COPPER RISER.	McGUIRE MANUFACTURING			
	HEAVY DUTY WAX BOWL RING. WAX GASKET FOR SETTING ANY FLOOR TYPE WATER CLOSET BOWL.	OATEY 31190			
	LAVATORY, ADA				
	DECLYN WALL HUNG SINK, VITREOUS CHINA, FAUCET HOLES ON 4" CENTERS.	AMERICAN STANDARD #0321.075	1-1/4"	1/2"	1/2"
	FAUCET: THERMOSTATIC ASSE 1070 LISTED, 4" CENTERS, LEAD FREE CAST BRASS, 6" SINGLE LEVER HANDLE, DECK PLATE	 WATTS #P1070-6			
	STOPS/ACCESSORIES: 1/2" CHROME PLATED BRASS WHEEL HANDLE ANGLED STOP, CHROME PLATED STEEL FLANGE AND 12" FLEXIBLE CHROME PLATED COPPER LAVATORY RISERS. GRID DRAIN WITH OFFSET TAILPIECE AND CHROME PLATED P—TRAP	McGUIRE MANUFACTURING			
	MOUNT AT HANDICAPPED HEIGHT. SUPPLY CONCEALED ARM SUPPORT CARRIER FOR MOUNTING OF LAVATORY.				
S-1	SINK CINOLE COMPARTMENT OF CAUGE TYPE 704 CTAINLESS STEEL	FIVAV	1-1/2"	1/2"	1/2"
	SINGLE COMPARTMENT, 20 GAUGE, TYPE 304 STAINLESS STEEL, 17"D x 21"W x 7" DEEP BOWL	ELKAY CR1721			
	FAUCET: CHROME PLATED BRASS, CONCEALED MIXING FAUCET, GOOSENECK SPOUT, WRIST BLADE HANDLES	ELKAY LK810HA08T4			
	DRAIN: STAINLESS STEEL PERFORATED STRAINER GRID.	ELKAY LK18			
	STOPS/ACCESSORIES: 1/2" CHROME PLATED BRASS WHEEL HANDLE ANGLED STOPS, PVC P-TRAP	MCGUIRE, CS & B			
	ELECTRIC WATER COOLER, ADA BI-LEVEL PRESSURE DRINNKING WATER COOLER. DELIVER 8 GPH OF WATER AT 50°F COOLED FROM 80°F INLET WATER AT 90°F AMBIENT. EACH COOLER HAVE FRONT AND SIDE MOUNTED PUSH PADS. HEAVY DUTY GALVANIZED FRAME SHALL SUPPORT POWDER COATED GALVANIZED EXTERIOR PANELS.	SUNROC ADAD8BL	1-1/4"	1/2"	_
IM-1	ICE MAKER SUPPLY BOX	OLIV ODAY	_	1/2"	_
	GALVANIZED STEEL (UNPAINTED) FINISH ICE MAKER BOX. 11-5/8"W X 9-1/2"H OVERALL DIMENSIONS WITH 1/2" FIP INLET X 1/4" OD OUTLET COMPERSSION ANGLE VALVE AND 1/2" MPT SUPPLY CONNECTION.	GUY GRAY #BIM876			

PLUMBING MATERIAL SPECIFICATIONS

SANITARY WASTE/VENT PIPING:

TUBE: PVC SCHEDULE 40 DWV, ASTM D 1785, FOAM CORE NOT ACCEPTED FITTINGS: PVC PLASTIC FITTINGS, SCHEDULE 40, ASTM D 2466, FOAM CORE NOT ACCEPTED JOINTS: SOLVENT CEMENTS FOR PVC PIPE AND FITTINGS, ASTM D 2564. FOAM CORE NOT ACCEPTED PROVIDE FIRE WRAP FOR PVC PIPE IN PLENUM CEILING AREAS, 3M FIRE BARRIER PLENUM WRAP 5A OR EQUAL

DOMESTIC WATER PIPING:

TUBE: CPVC, SCHEDULE 40 PIPE. PLASTIC HOT AND COLD WATER DISTRIBUTION SYSTEMS, ASTM F441 FITTINGS: CPVC PLASTIC FITTINGS, SCHEDULE 40, ASTM F438. JOINTS: SOLVENT CEMENTS FOR CPVC PIPE AND FITTINGS. ASTM F493

NOTE: PIPING MATERIAL SPEC SHALL HAVE A FLAME SPREAD INDEX OF 25 OR LESS AND SMOKED DEVELOPED INDEX OF 50 OR LESS FOR AIR PLENUM APPLICATION.

ALL VALVES FOR DOMESTIC WATER USAGE SHALL BE A MIN. 125# BRONZE, FULL PORT, BALL VALVE, THREADED. OPERATING PRESSURE SHALL NOT EXCEED 80% OF THE VALVE PRESSURE CLASS.

PROVIDE PIPING HANGERS AND SUPPORTS SIZED AND SPACED PER CURRENT LOCAL CODE AND PROVIDE 6" SADDLES UNDER ALL INSULATED PIPING

SHOCK ARRESTORS


PROVIDE SHOCK ARRESTORS PER CODE SIZED TO PDI STANDARDS. AIR CHAMBERS ARE NOT ACCEPTABLE.

TRAP PRIMERS

PROVIDE TRAP PRIMERS FOR ALL FLOOR AND HUB DRAINS

	PUMP SCHEDULE												
NO.	MANUFACTURER	MODEL NO.	QUANTITY	GPM FLOW	HEAD PRESSURE	POWER	H.P.	RPM	REMARKS				
RP-1	GRUNDFOS	UP-25-64 SF	1	2.0 GPM	1.7 FT (.75 PSI)	115/1/60	1/12	SINGLE SPEED	DOMESTIC HOT WATER RECIRCULATING PUMP.				
NOTES:	1. –												


RISER DIAGRAM - PLUMBING

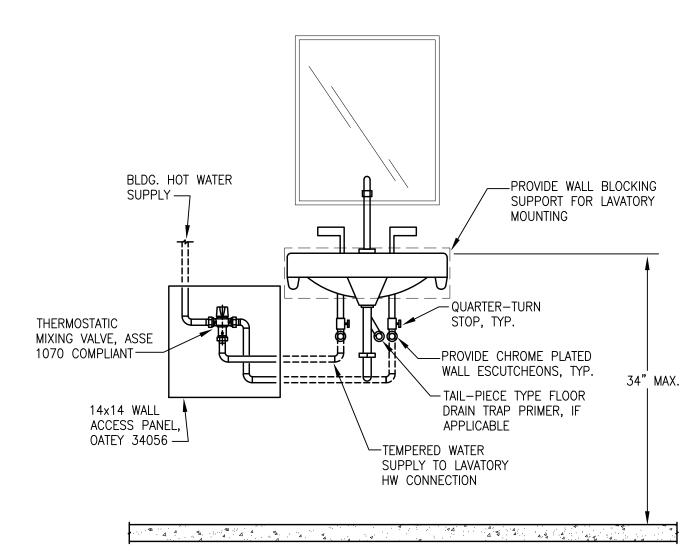

- 1. TMV VALVE AND ALL ASSOCIATED PIPING SHALL BE RECESSED WITHIN THE WALL CAVITY, COORDINATE WITH THE G.C. FOR EXTRA WALL FURRING AS REQUIRED
- FOR ADEQUATE SPACE. PROVIDE BLOCKING TO MOUNT TMV AS REQUIRED. 2. THE ONLY EXPOSED PIPING SHALL BE THE COLD, TEMPERED, TRAP PRIMER (IF APPLICABLE), AND DRAIN FOR THE LAVATORY, ALL PIPING HELD AS HIGH AS
- DROP-IN STYLE LAVATORY SIMILAR, PROVIDE TMV RECESSED IN WALL.
 PROVIDE LAV-GUARD INSULATION KIT FOR ALL EXPOSED PIPING.

LAVATORY DETAIL

PLUMBING LEGEND

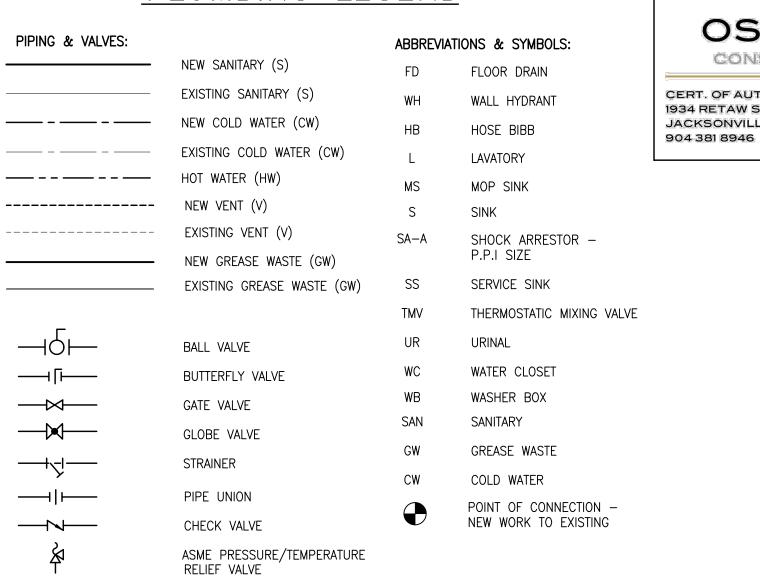

OSSI+MYLER CONSULTING ENGINEERS

CERT. OF AUTH #8868 ALONZO MYLER, P.E. 1934 RETAW STREET FL LIC #55353 JACKSONVILLE, FL 32210

PLUMBING GENERAL NOTES


PIPE UP

PIPE DOWN

O— - —

C—-—

- 1. ALL WORK SHALL BE PERFORMED IN ACCORDANCE WITH THE 2017 FLORIDA BUILDING CODE 6TH EDITION - PLUMBING, NFPA 70, NFPA 101, AND THE AMERICAN DIABILITIES ACT (ADA).
- 2. PLANS ARE NOT COMPLETELY TO SCALE, PIPE ROUTING SHOWN IS SCHEMATIC AND IS NOT INTENDED TO INDICATE EXACT ROUTING AND ANY ADDITIONAL OFFSETS AND FITTINGS REQUIRED FOR PROPER INSTALLATION AND TO MAINTAIN CLEARANCES. VERIFY STRUCTURAL, MECHANICAL AND ELECTRICAL INSTALLATIONS AND OTHER POTENTIAL OBSTRUCTIONS AND ROUTE PIPING TO AVOID INTERFERENCES.
- 3. SLEEVE AND FIRE STOP PENETRATIONS OF RATED WALLS, FLOORS, CEILINGS AND ROOFS. FLASH AND COUNTERFLASH ROOF PENETRATIONS.
- 4. PROVIDE SHOP DRAWINGS OF PLUMBING FIXTURES, PIPING MATERIALS, FITTINGS, INSULATION, VALVES, AND EQUIPMENT FOR REVIEW BY ENGINEER OF RECORD. SHOP DRAWINGS SHALL BE IN ELECTRONIC FORMAT, BE COMPLETE INCLUDING ALL ITEMS REQUIRED IN THE PLUMBING CONTRACT WITH SPECIFIC COLORS, SIZES, MODELS, ETC CHECKED ON APPROPRIATE PAGES. IN-COMPLETE BOOKLETS PUT TOGETHER BY A FIXTURE MANUFACTURER WILL BE REJECTED AND RETURNED.

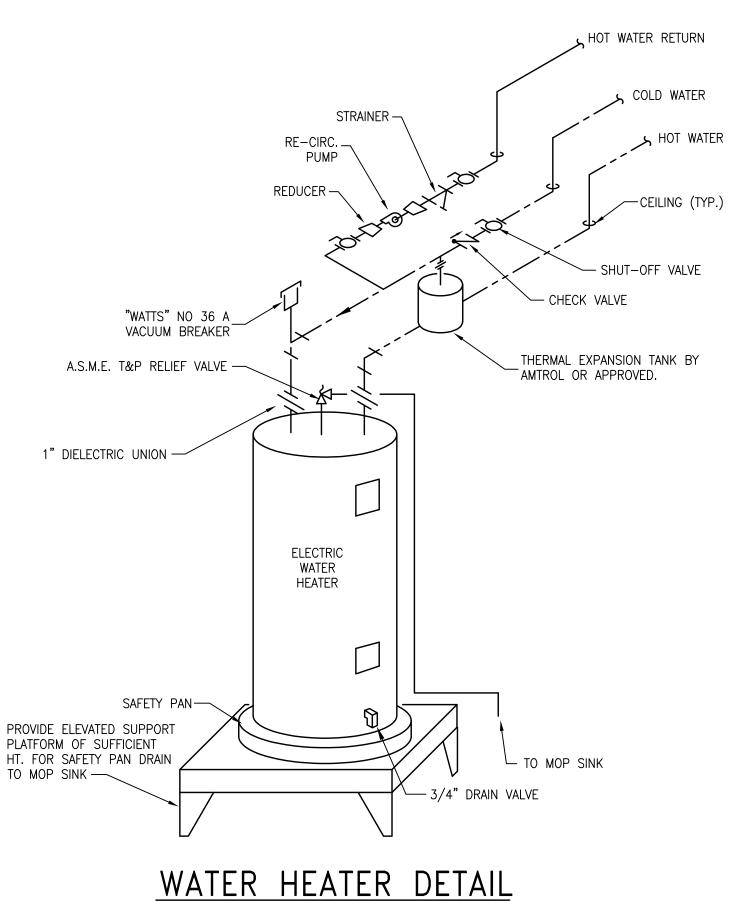

OPMEI orporate

AL

MEDIC/

COASTA

.UMBING -PL VENUE


REVISIONS

SCHEDULE

04/30/2019

JOB NUMBER <u>SCALE</u>

AS NOTED DRAWING NUMBER

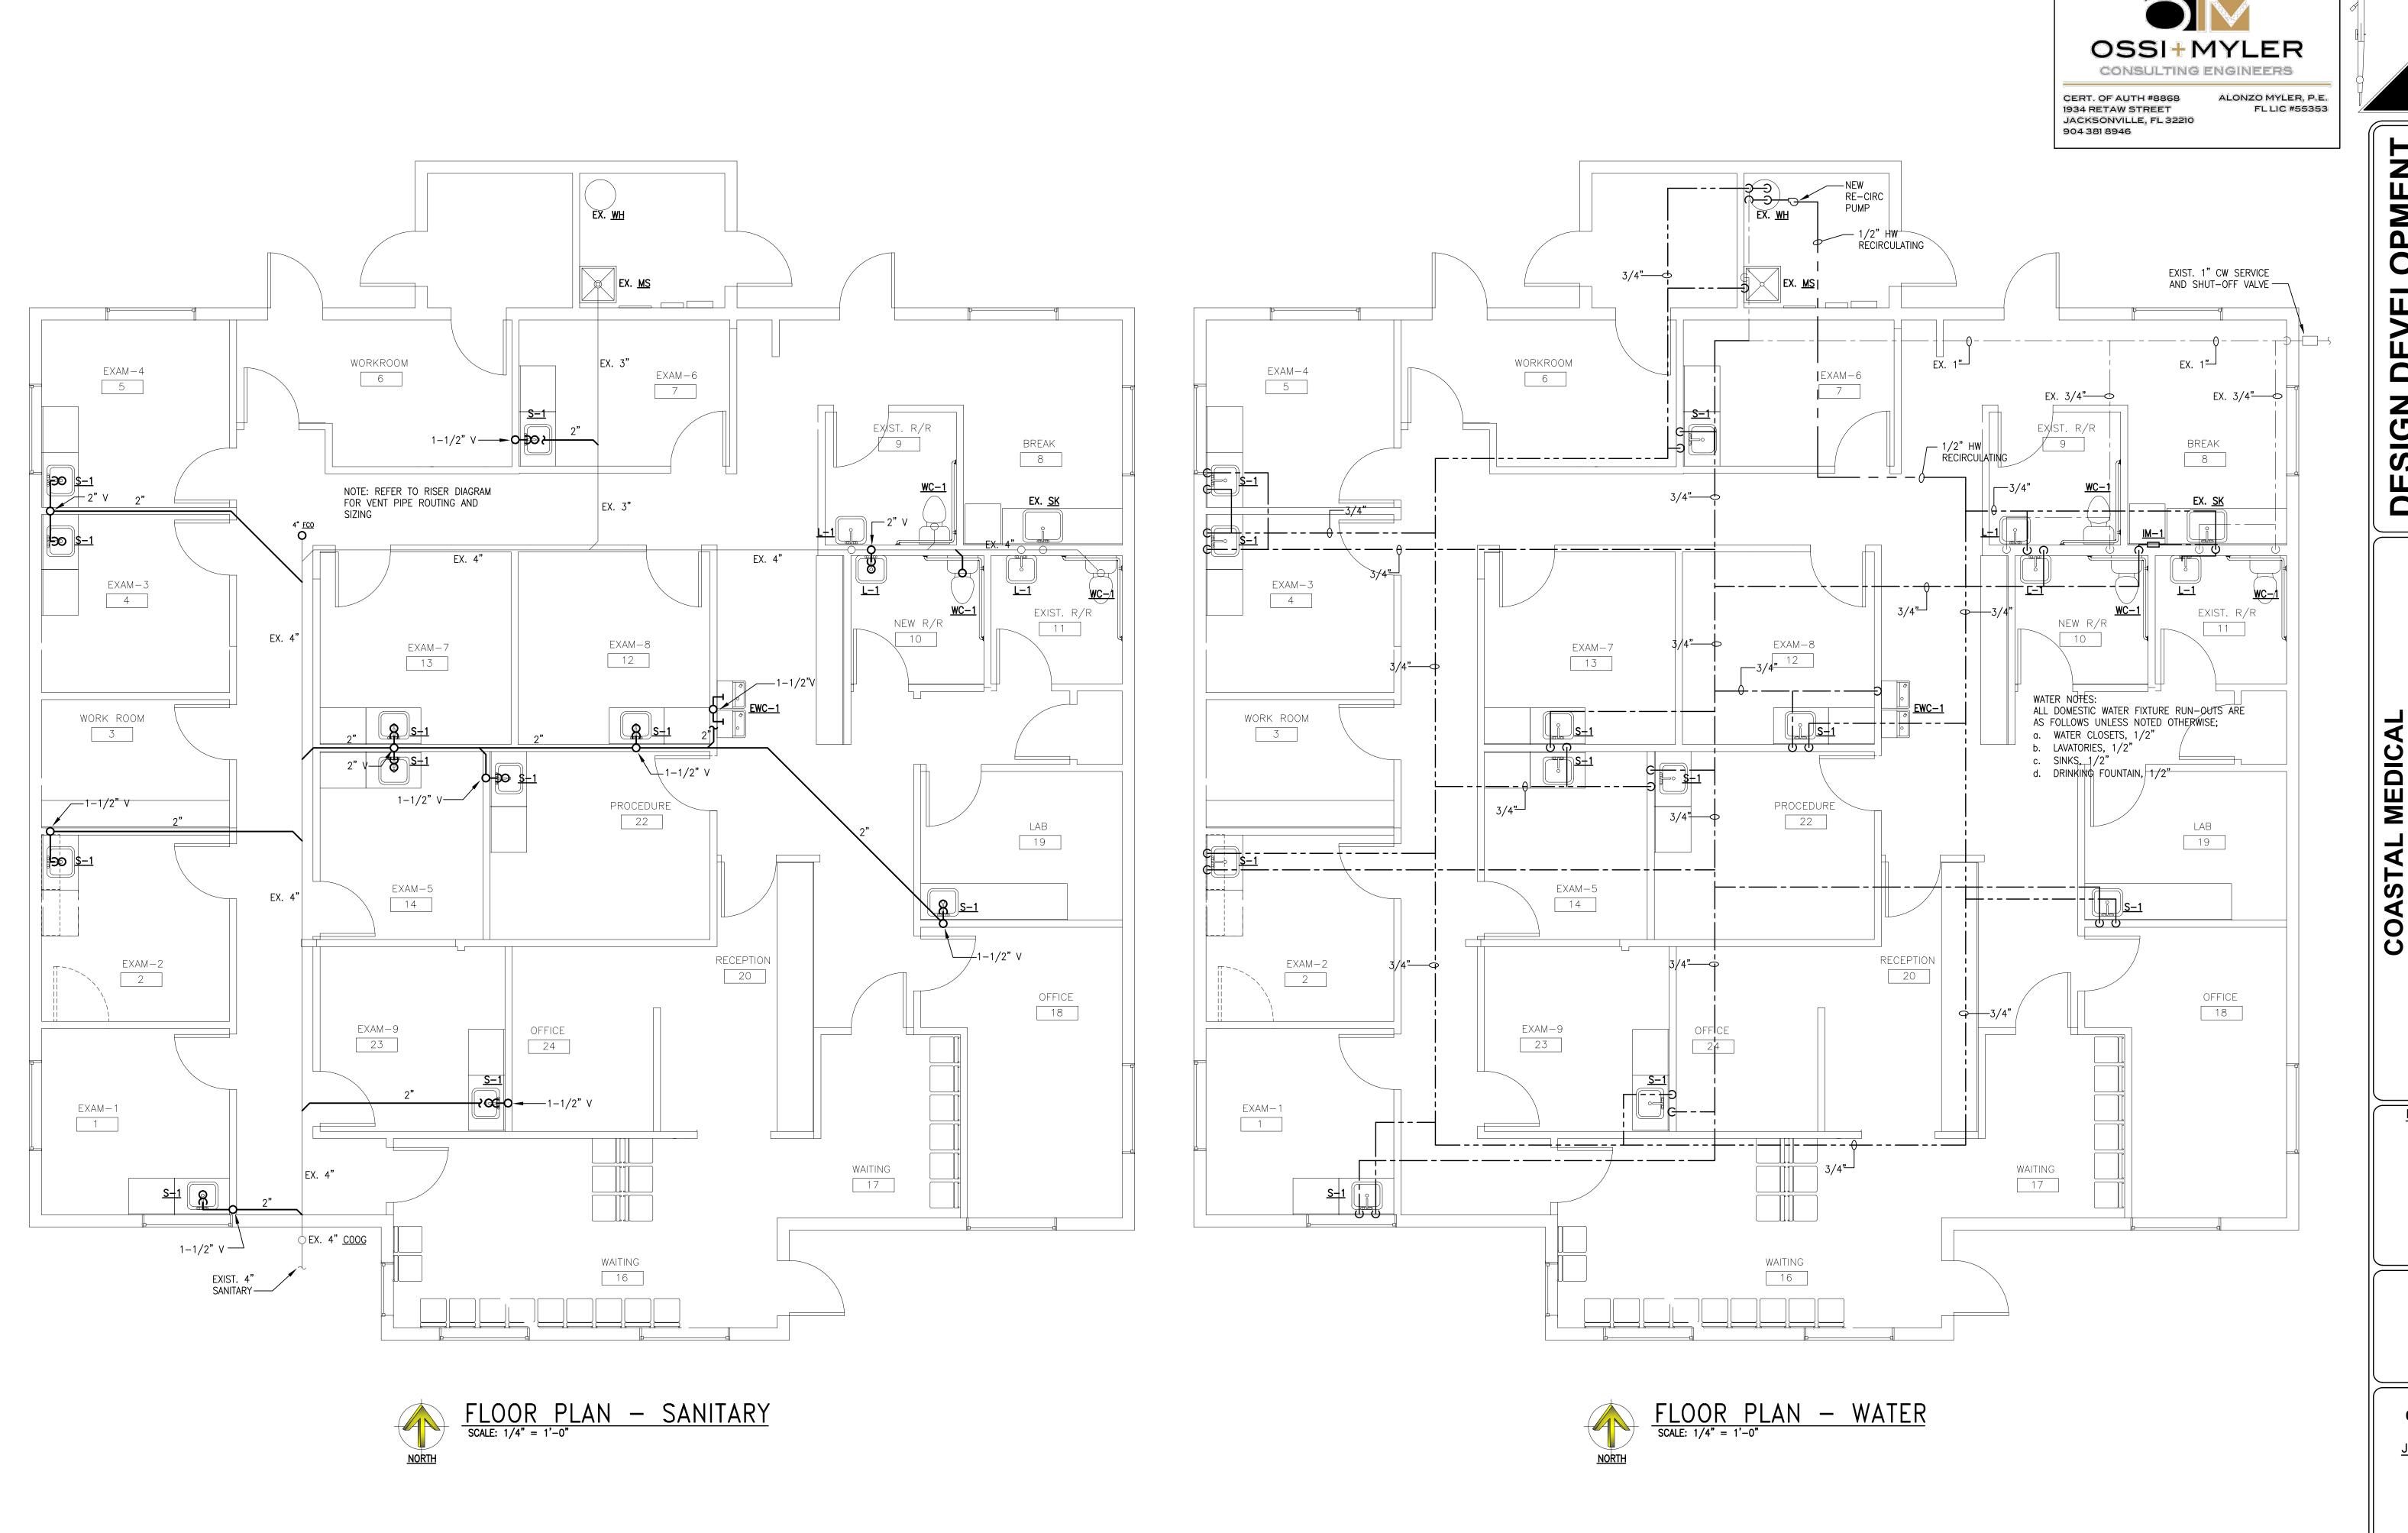

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COASTAL MEDICAL
421 KINGSLEY AVENUE
ORANGE PARK, FL
FLOOR PLAN - PLUMBING

REVISIONS

_

04/30/2019

JOB NUMBER

1924

SCALE AS NOTED

P-1

FLOOR PLAN — MECHANICAL SCALE: 1/4" = 1'-0"

KEYNOTES

1 6"ø UP TO ROOF INTAKE VENT, PROVIDE BALANCING DAMPER

3) PROVIDE NEW PROGRAMMABLE THERMOSTAT

(2) PROVIDE NEW EXHAUST FAN AND SOFFIT VENT, CONTROL VIA OCC SENSOR SWITCH

	l [OIFFUS	IFFUSER SCHEDULE									
TYPE	SERVICE	CFM F	RANGE	MODULE	NECK	MODEL						
Δ	SERVICE	MIN	MAX	SIZE	NECK	MODEL						
	SUPPLY-CEILING	0	100	24×24	6"	TITUS — OMNI						
		101	200	24x24	8"	TITUS — OMNI						
l R		201	325	24x24	10"	TITUS — OMNI						
	RETURN/EXHAUST	0	150	24x24	6"	TITUS 50F						
	CEILING	151	255	24x24	8"	TITUS 50F						
С		256	420	24x24	10"	TITUS 50F						
	SUPPLY - CEILING	0	60	12x12	4"	TITUS — OMNI						
	•	61	100	12x12	6 "	TITUS — OMNI						

NOTES:

1. DIFFUSER RUNOUT SIZE SHALL BE DIFFUSER NECK SIZE, UNLESS OTHERWISE NOTED ON PROVIDE OPTIONAL MOLDED INSULATION BLANKET R-6 FOR SUPPLY AND RETURN DIFFUSERS.

DESIGN CONDITIONS

GENERAL NOTES AND SPECIFICATIONS

2. ALL AIR DISTRIBUTION COMPONENTS SHALL COMPLY WITH SECTION 13-410 OF THE FBCB.

ANY NEW SUPPLY AND RETURN DUCTS FOR THE SPACE SHALL BE RIGID, FIBERGLASS DUCT-BOARD, 1.5" THICK, FLEXIBLE DUCTS SHALL BE R-6.5 CLASS 1, NOT EXCEED 10'. WHERE BRANCH DUCTS EXCEED 10' IN LENGTH PROVIDE ROUND SHEET-METAL DUCT

EXTENSION INSULATED WITH 2" FIBERGLASS DUCT WRAP PRIOR TO TRANSITION TO FLEXIBLE

ALL WORK SHALL BE IN ACCORDANCE WITH THE FBCM 2017, 6TH EDITION.

. TEST AND BALANCE SHALL BE BY MECHANICAL CONTRACTOR.

7. PROVIDE 1 YEAR WARRANTY ON LABOR AND MATERIAL BY CONTRACTOR.

EXTERIOR DESIGN CONDITIONS SUMMER; DRY/WET BULB 96°F/77°F WINTER; DRY BULB 29°F

INTERIOR DESIGN CONDITIONS SUMMER; OWNER HAS ELECTED TO RE-USE THE EXISTING A/C EQUIP. WINTER; 68°F



EXISTING EXHAUST GRILLE

1934 RETAW STREET JACKSONVILLE, FL 32210 904 381 8946

FL LIC #55353

OPMEN corporated

DESIGNArchitect

MECHANICAL LEGEND

	EXISTING FIRE DAMPER W/ACCESS DOOR		EXISTING DUCT/EQUIP. TO REMAIN
\boxtimes	CEILING SUPPLY DIFFUSER	\$//////	EXISTING DUCT/EQUIP. TO BE DEMOL
	CEILING RETURN GRILLE	//////// /	, .
	EXISTING CARBON FILTER SCRUBBER	(<u>T</u>)	EXISTING THERMOSTAT
\boxtimes	CEILING SUPPLY DIFFUSER		EXISTING FLEXIBLE DUCT
	CEILING RETURN GRILLE		
	CEILING EXHAUST GRILLE/FAN		RELOCATION ARROW
ф	SPIN-IN TAP AND FLEX DUCT W/ MAN. VOL. DAMPER	ES	EXISTING SUPPLY REGISTER
0	REFRIGERANT PIPING	ER	EXISTING RETURN GRILLE
T	RELOCATED THERMOSTAT LOCATION	CC	EVICTING EVILATION OBJECT

FLEXIBLE DUCT

	E	XISTI	NG	Α,	/C	EC)UIF	PME	INT	S	CHE	DU	LE							
	AIR F	AIR FLOWS FAN DATA COOLING COIL						UNIT ELEC. DATA				SYSTEM								
NOMINAL	IINAL TOTAL	TOTAL OA	EXT.	TOT.	HP	TYPE	DE	SIGN C	ONDITIO	NS	SEN.	TOTAL	MAX.	HEAT.	HEAT	MCA	МОСР	VOLT/	SEER/	UN
TONS	CFM	CFM	SP	SP	ПР	ITPE	EDB	EWB	LDB	LWB	MBH	MBH	FPM	KW	STAGES	MCA	MUCP	PHASE	EER	W
5	1860	150	0.8	_	_	FC	_	_	_	_	_	_	_	10.0	_	_	60	208/1	13.0	-

AHU/HP-2

AHU/HP-1

RE-BALANCE UNITS TO THE SCHEDULED VALUES.

BASIS OF DESIGN

TRANE TWE/TWR-060

TRANE TWE/TWR-060

- PROVIDE THE FOLLOWING OPTIONS/ACCESSORIES IF NOT EXISTING; a. MOTORIZED TWO-POSITION OUTSIDE AIR DAMPER.
- b. TEST EXISTING DUCT SMOKE DETECTORS AND AUDIBLE-VISUAL INDICATORS FOR PROPER OPERATION.

ROOF-TOP UNIT SEQUENCE OF OPERATION:


- 1. SUPPLY FAN IS ENERGIZED BY A TWO POSITION SWITCH. WHEN THE SWITCH IS CLOSED IT SHALL ENERGIZE THE SYSTEM PROVIDING POWER TO ALL
- COMPONENTS AND LOW VOLTAGE CONTROL TO ALL CONTROL DEVICES. 2. ROOF-TOP UNIT SHALL BE CONTROLLED WITH A WALL MOUNTED THERMOSTAT DEVICE CONTROLLING SPACE TEMPERATURE. THE THERMOSTAT SHALL INCLUDE OFF-AUTO-COOLING-HEATING MODES AND TIME-DAY-WEEK SCHEDULING
- 3. OCCUPIED MODE COOLING; OUTSIDE AIR DAMPER SHALL OPEN, WHEN THE SPACE TEMPERATURE RISES ABOVE THE SETPOINT THE COMPRESSOR/S SHALL CYCLE TO MAINTAIN ROOM TEMPERATURE.
- 4. OCCUPIED MODE HEATING; OUTSIDE AIR DAMPER SHALL OPEN, WHEN THE SPACE TEMPERATURE FALLS BELOW THE SETPOINT THE ELECTRIC HEAT SHALL ENERGIZE TO MAINTAIN ROOM TEMPERATURE.

5. UNOCCUPIED MODE; UNIT SHALL DE-ENERGIZE AND OUTSIDE AIR DAMPER


SHALL CLOSE. 6. THE SYSTEM SHALL IMPOSE A 30 SECOND TIME DELAY TO RESTART THE SUPPLY FAN, COMPRESSORS, AND CONDENSER FANS AFTER SYSTEM SHUT

	FAN SCHEDULE										
PLAN BASIC OF DESIGN TYPE CFM STATIC PRESS. FAN MOTOR VOLT/ DRIVE INTE										INTERLOCK	
MARK	DASIC OF DESIGN	111 E	CI W	IN. WG.	RPM	RPM	HP	PHASE	TYPE	INTENEOUR	
EF-1,2,3	AM. COOLAIR	CEIL.	70	0.125	_	_	48W	_	1	SWITCH	
NOTES:	NOTES:										

PROVIDE 6" ROUND SHEET-METAL EXHAUST DUCT TO NEW SOFFIT VENT. 2. PROVIDE BACK-DRAFT DAMPER IF NOT INTEGRAL WITH FAN.

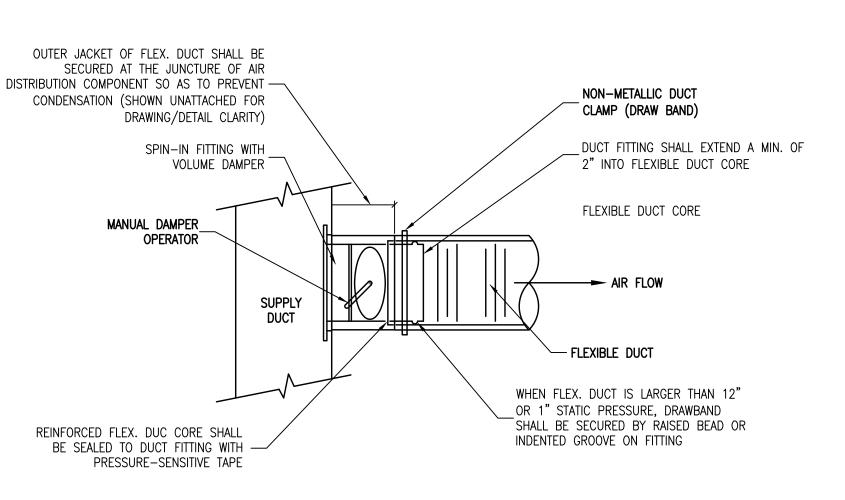

TYPICAL FLEXIBLE DUCT CONNECTION

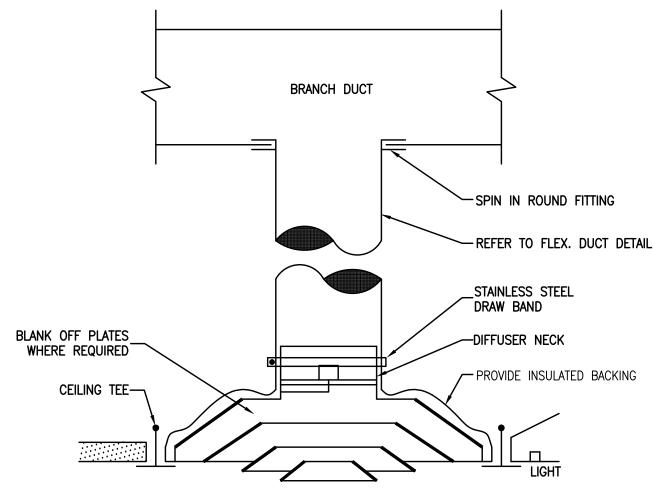

DIFFUSER MOUNTING DETAIL

04/30/2019

421 KINGSLE ORANGE P. FLOOR PLAN

REVISIONS

OA

JOB NUMBER <u>SCALE</u>

AS NOTED DRAWING NUMBER

EX LOCA FED	TION: EXIST. BREAK ROOM	208/120 200 AM FLUSH	IPS [_	s <u>4</u> BREAKE ACE MO		MAIN LUGS ONLY	42,000 A SYM. SHORT CIRCUIT CURRENT RATING @ 240V, 3ø
СКТ	DESCRIPTION OF LOAD	TRIP	ØΑ	KVA ØB	ФC	TRIP	DESCRIPTION OF I	LOAD CKT
1	EXIST AHU-1	60	5.5 2.3		70	30	WATER HEATER	2 2
3	7 7	7		5.5		\	+ +	4
5	EXIST AHU-2) 60			5.5 5.0	60	EXIST HP-1	4 6
7	\frac{1}{4} \qquad \frac{1}{4}	\frac{1}{1}	5.5 5.0			7		∜ 8
9	RECEPTACLES 3	20		1.1 5.0		60	EXIST HP-2	4 10
11	QUAD RECEPTACLE PHONE BOARD 3	20			0.4 5.0	7	<u> </u>	∜ 12
13	RECEPTACLES 3	20	1.1 0.8			20	RECEPTACLE DRINKING FOUNTAIN	3 14
15	RECEPTACLES 3	20		1.4		20	RECEPTACLE COPIER	3 16
17	RECEPTACLES 3	20			1.4 0.8	20	RECEPTACLES LAB	3 18
19	RECEPTACLES 3	20	1.3 0.8			20	RECEPTACLES LAB	3 20
21	RECEPTACLE BREAK ROOM REFRIGERATOR 3	20		1.0		20	SPARE	3 22
23	RECEPTACLES 3	20			1.6 0.4	20	RECEPTACLES BREAK ROOM	3 24
25	RECEPTACLES 3	20	1.4			20	LIGHTING	3 26
27	SPARE	20		- /1.1		20	LIGHTING	3 28
29	SPARE	20			- 0.2	20	RECIRC PUMP RP-1	3 30
31	SPARE	20	-/_			20	SPARE	32
33	SPARE	20		-/_		20	SPARE	34
35	SPARE	20			-/_	20	SPARE	36
37	SPARE	20	-/_			20	SPARE	38
39	SPARE	20		- 0.6		20	EXIST. SIGN	40
41	SPARE	20		0.0	- 0.2	20	EMERGENCY & EXIT LIGHTING	3 42
			25.4	21.2	20.3		TOTAL CONNECTED KVA: 6	6.9 (186A)

PANEL SCHEDULE # NOTES:

- (1) PROVIDE UPDATED TYPEWRITTEN OR COMPUTER PRINTED PANEL DIRECTORY INSIDE PANEL DOOR.
- 2) PROVIDE NEW BREAKER AS INDICATED. ALL NEW BREAKERS SHALL MATCH EXISTING PANEL AND BREAKER TYPES.
- (3) RE-USE EXISTING BREAKER, PROVIDE NEW CIRCUIT WIRING AND CONDUIT.
- (4) EXISTING BREAKER, WIRING, AND CONDUIT TO REMAIN.

LOAD CALCULATION		
Commercial X Metered Main X Number of Meters_ Overhead Underground X Underground Up Pole_		
Lighting @ 125% Receptacle Load @ ((100%KVA - 10KVA)*.5) + 10KVA HVAC & Misc Load @ 100%	3,250 11,850 46,500	- VA - VA - VA
Voltage <u>208</u> Phase <u>3</u> Tota	ol <u>61,600</u> ol <u>171</u>	_ VA _ Amps

LABEL REQUIREMENTS

LEGIBLY MARKED WITH THE MAXIMUM FAULT CURRENT AVAILABLE, SEE FAULT CURRENT CALC AND PANEL SCHEDULES. 2. PER NEC 110.22, EACH DISCONNECTING MEANS SHALL BE LEGIBLY MARKED TO IDENTIFY ITS

PURPOSE.

PER NEC 110.24, SERVICE EQUIPMENT SHALL BE

- 8. LOCATIONS OF RECEPTACLES FOR PLUG-IN EQUIPMENT AND FEED FOR DIRECT-CONNECT EQUIPMENT ARE APPROXIMATE AND SHALL BE APPROVED PRIOR TO FINAL 2. ALL WIRING TO BE THHN SOLID COPPER. CONDUIT SHALL BE ELECTRICAL METALLIC TUBING (EMT),
- RIGID STEEL (1/2" MINIMUM), OR MC CABLE WHERE ALLOWED BY CODE. WHERE MC CABLÉ IS USED, PRÒPER SECUREMENT AND SUPPORT (AT INTERVALS NOT EXCEEDING 6 FEET) 9. EXTERIOR A/C MAINTENANCE RECEPTACLES SHALL BE INSTALLED USING RIGID NEMA
- 3. NEUTRAL WIRES SHALL BE SIZED IDENTICALLY WITH PHASE CONDUCTORS, UNLESS

GENERAL ELECTRICAL NOTES & SPECIFICATIONS

- 4. ALL CONDUCTORS SHALL BE #12 AWG UNLESS OTHERWISE INDICATED IN THIS DRAWING OR PANEL SCHEDULES.
- 5. ALL LIGHTING AND RECEPTACLE CIRCUITS SHALL BE RUN WITH A #12 GREEN WIRE UNLESS OTHERWISE INDICATED. ALL OTHER BRANCH CIRCUITS SHALL INCLUDE A GREEN GROUND WIRE SIZED AS SHOWN IN THIS DRAWING.

SHALL BE FOLLOWED PER NEC ART. 330.


OTHERWISE IDENTIFIED IN THIS PLAN.

- 6. EQUIPMENT AND LIGHTING SHALL NOT EXCEED THE POWER REQUIREMENTS SPECIFIED IN THE EQUIPMENT AND LIGHTING SCHEDULE.
- 7. MOUNT LIGHTING SWITCHES 48" AFF. MOUNT RECEPTACLES MINIMUM 18" AFF. UNLESS OTHERWISE INDICATED. LIGHTING SWITCHES AND RECEPTACLES MAY BE FIELD LOCATED TO ACCOMMODATE SERVICE TO DEDICATED EQUIPMENT, AS LONG AS THEY ARE INSTALLED A MINIMUM OF 18" AFF.

1. ALL WORK SHALL BE PERFORMED IN ACCORDANCE WITH THE CURRENT ADOPTED NATIONAL

ELECTRIC CODE (NEC) AND LOCAL CODES APPLICABLE TO THIS TYPE OF INSTALLATION.

- INSTALLATION. ALL EQUIPMENT SHALL BE INSTALLED ACCORDING TO THE OEM SPECIFICATION. COORDINATE SPECIAL RECEPTACLES WITH THOSE IDENTIFIED IN OEM SPECIFICATIONS.
- 3R RATED CONDUIT AND RECEPTACLE BOX.
- 10. INSTALL NEW SERVICE AND FEEDS AS IDENTIFIED IN THE POWER RISER DIAGRAM.
- 11. REFER TO MECHANICAL PLAN FOR MODEL, TYPE OF MECHANICAL EQUIPMENT.
- 12. NO MORE THAN (3) CURRENT CARRYING CONDUCTORS PER HOMERUN. 13. THESE DOCUMENTS PERTAIN TO ELECTRICAL ONLY. THIS DESIGN SHALL NOT BE USED
- TO QUALIFY OTHER DISCIPLINES NOR SHALL IT BE RESPONSIBLE FOR OTHER DISCIPLINE REQUIREMENTS OR PROPERTY ASSETS NOT A PART OF THE ELECTRICAL CONTRACT.
- 14. WIRE ALL EMERGENCY LIGHTS TO THE HOT SIDE OF THE SWITCH THAT OPERATES THE LIGHT FIXTURES THEY COVER.
- 15. PROVIDE PLENUM RATED CABLING/SHEATHING IN AREAS WITH RETURN AIR PLENUM. COORDINATE WITH MECHANICAL CONTRACTOR.
- 16. A LICENSED ELECTRICAL CONTRACTOR SHALL BE PRESENT AT ALL TIMES.

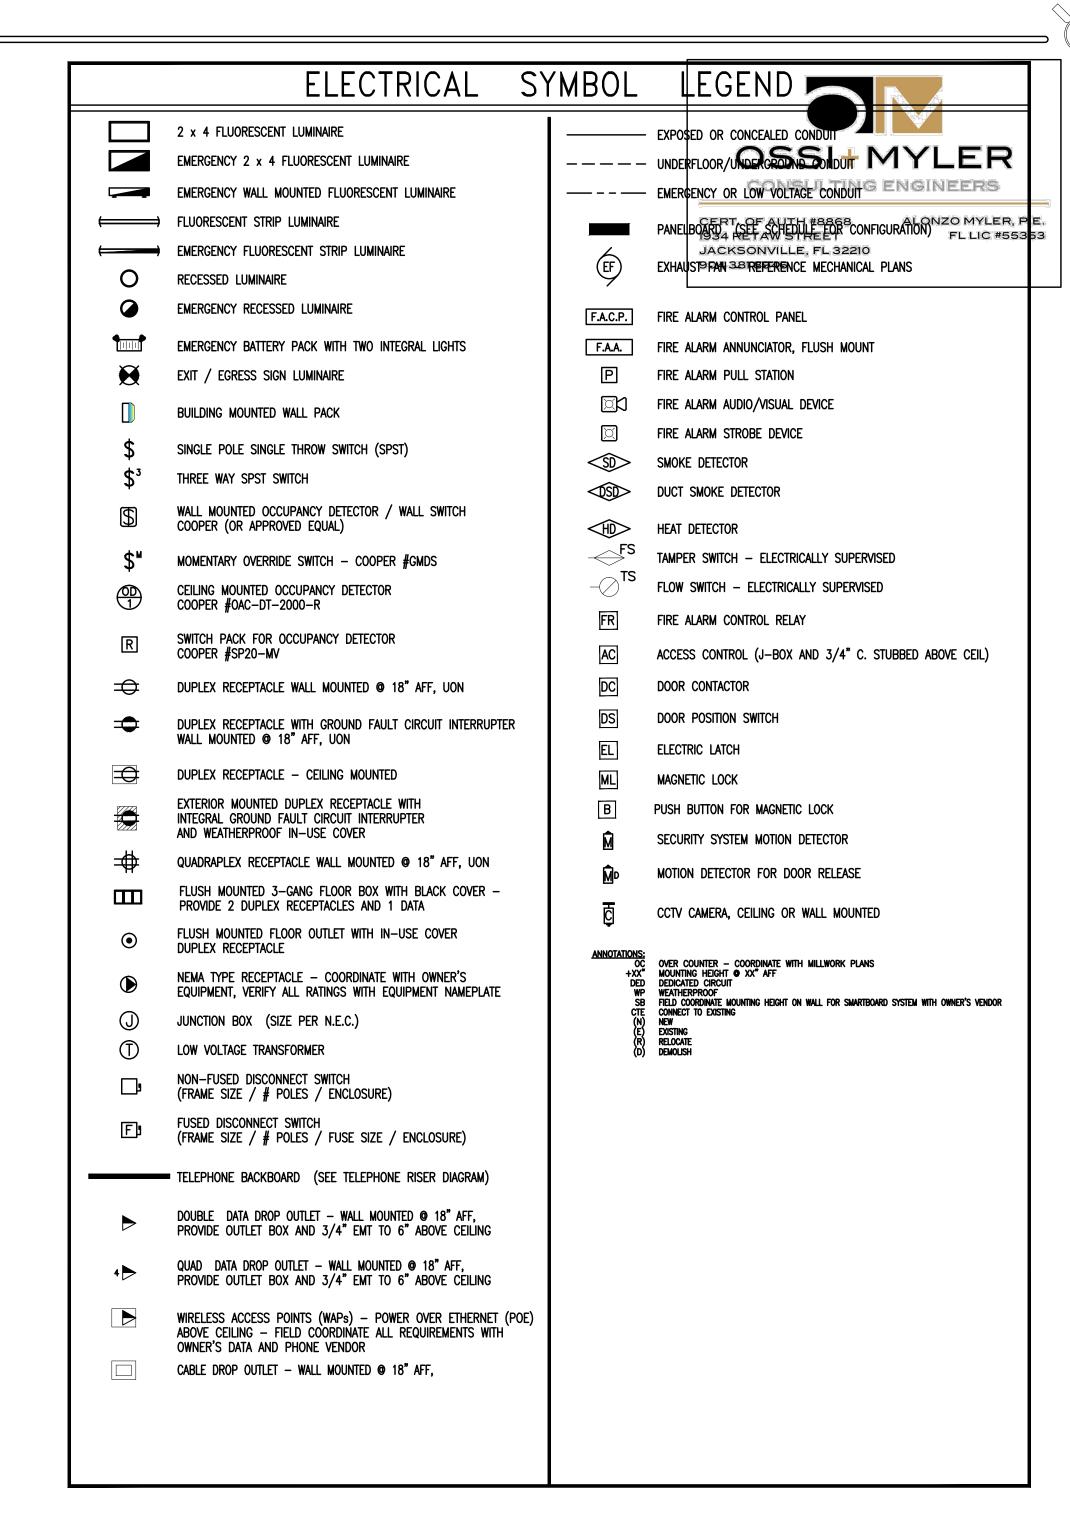

OPME: orporate

CTRICAL ENUE A DIC OA OF SCHEDULE


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1. ALL EMERGENCY EGRESS LUMINAIRES REQUIRE AN UNSWITCHED CONNECTION. WHERE EMERGENCY EGRESS DEVICES ARE CONTAINED WITHIN NORMAL USE LUMINAIRES, PROVIDE LOCAL SWITCHING AS INDICATED ON

2. FOR PRICING AND/OR ADDITIONAL INFO PLEASE CONTACT ARDD & WINTER, TIM SOHL 904-345-5809.

DRAWINGS AND AN ADDITIONAL UNSWITCHED CONNECTION TO EMERGENCY FIXTURE.

DESIGN | Architect

421 KINGSLEY AVENUE ORANGE PARK, FL FLOOR PLAN - ELECTRICAL

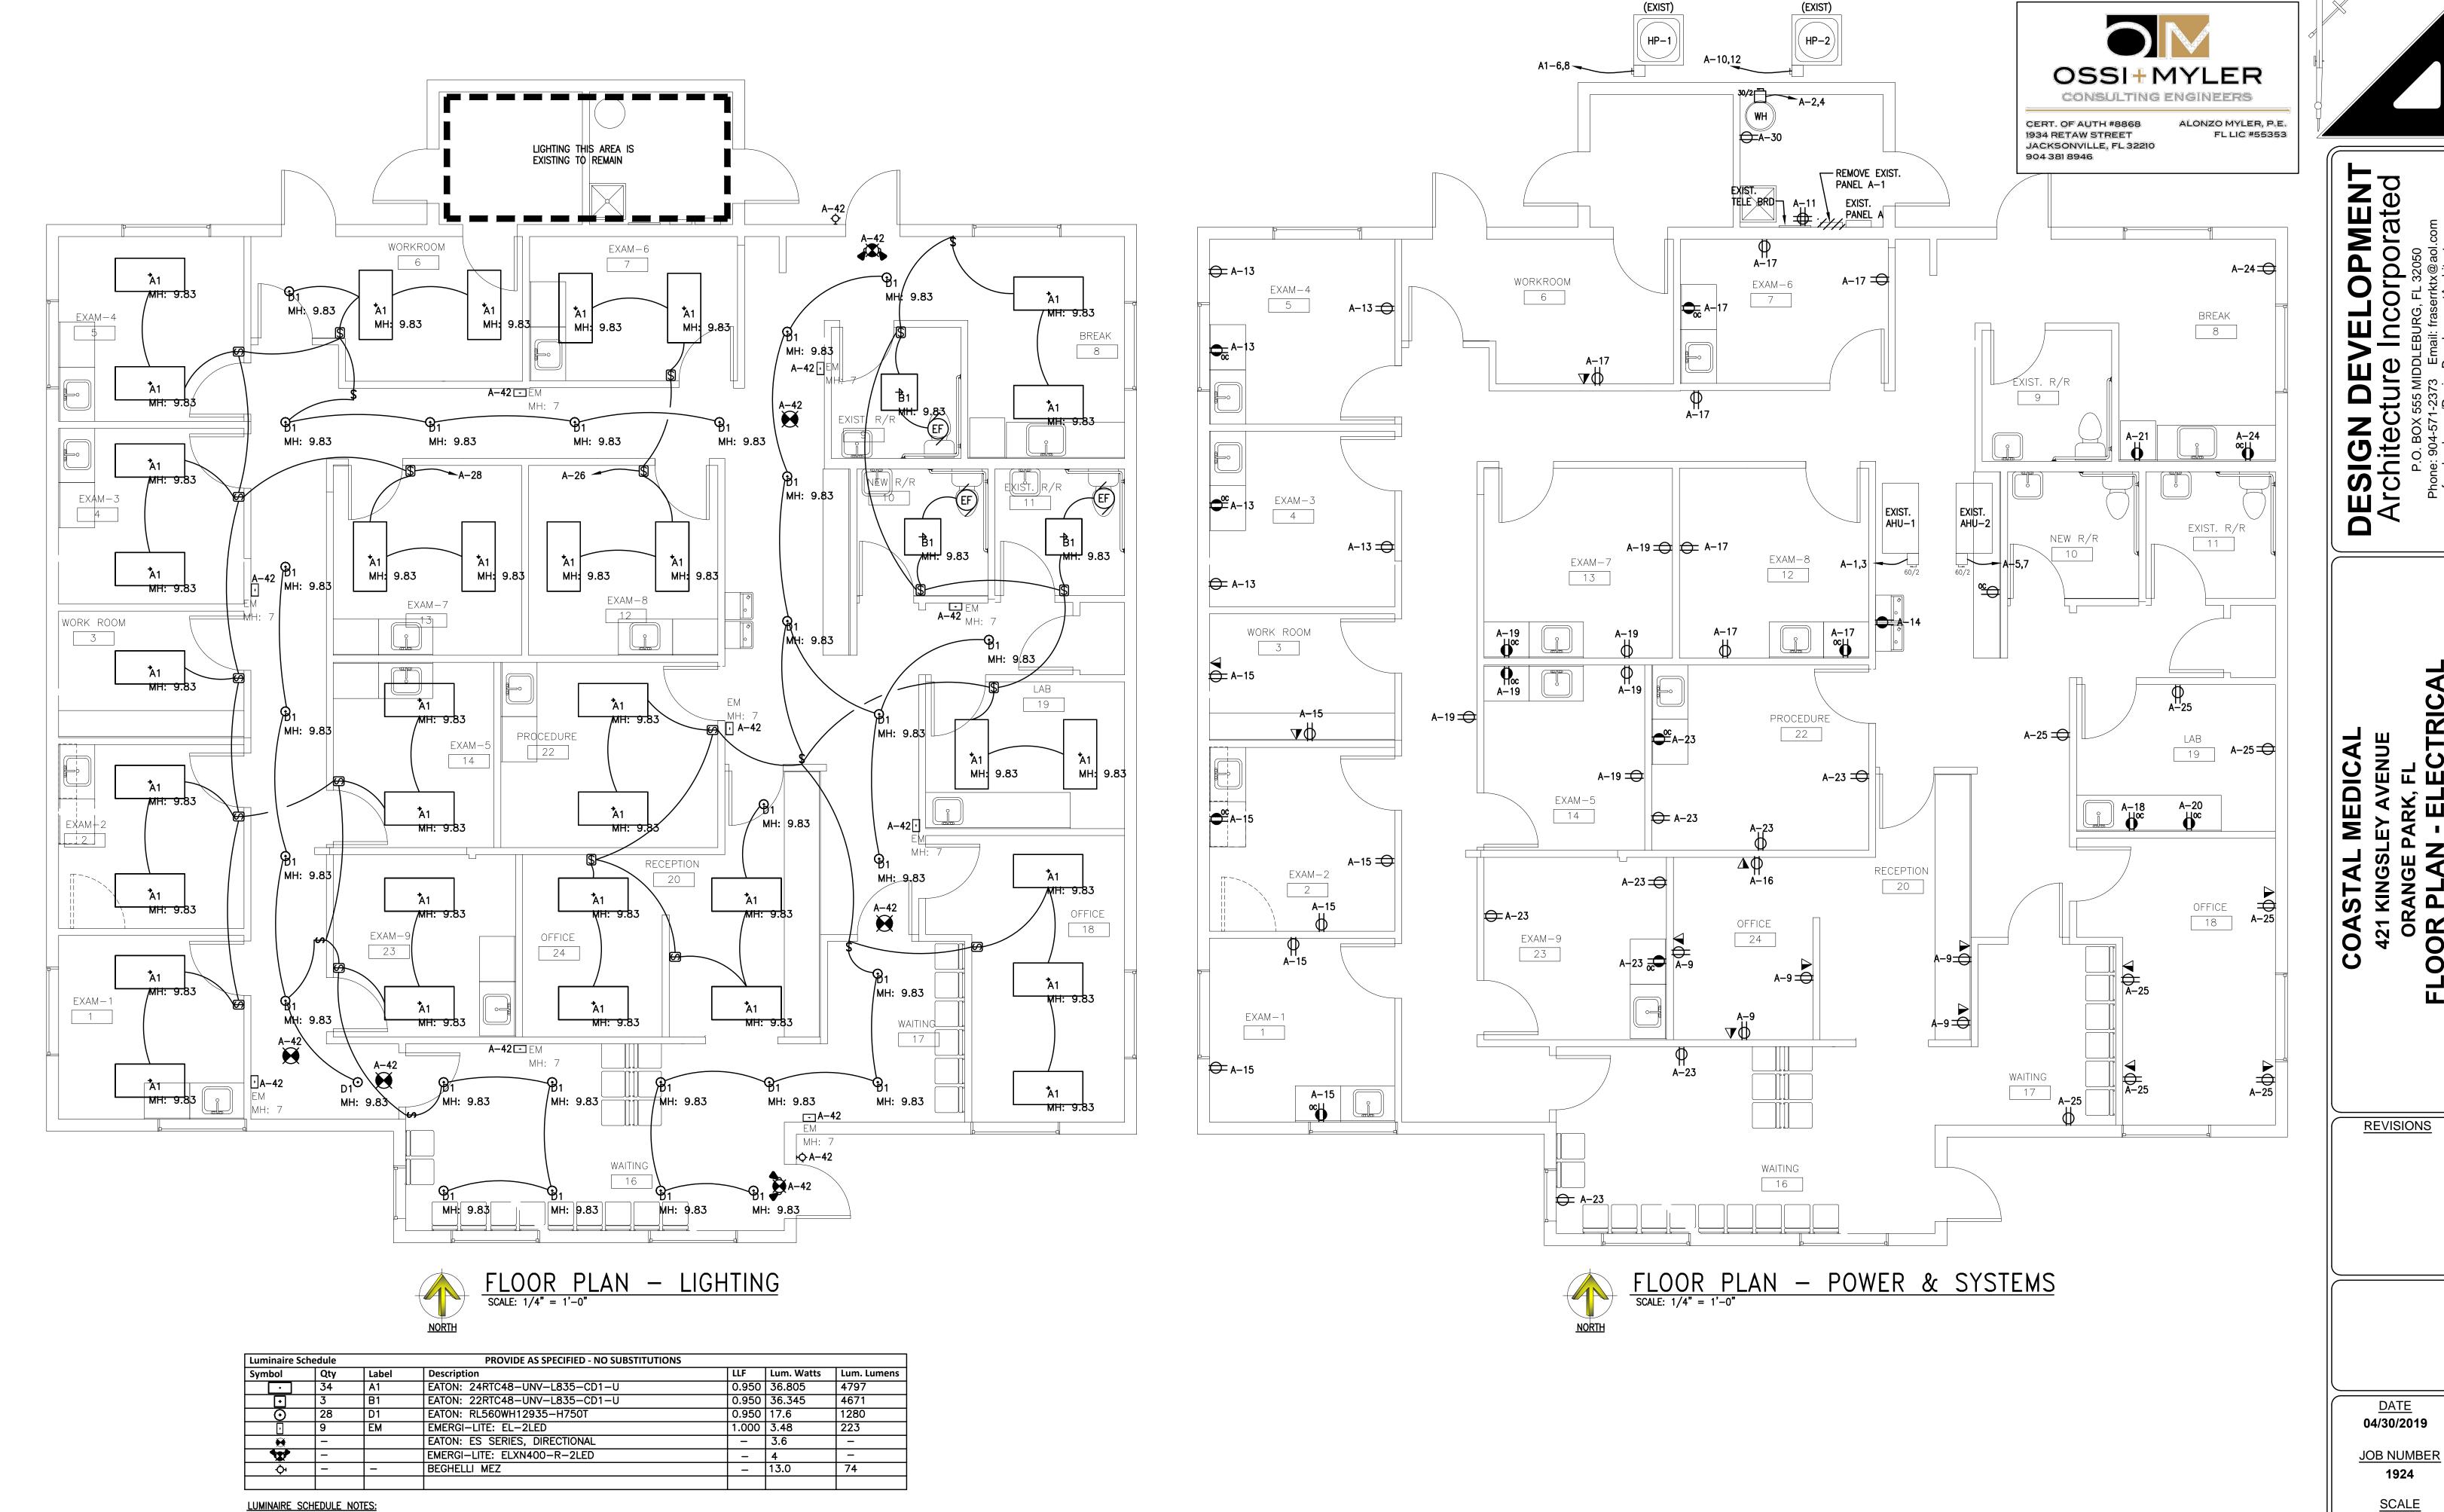REVISIONS

04/30/2019 JOB NUMBER

<u>SCALE</u> **AS NOTED**

DRAWING NUMBER E-1